COLLEGE PARK THE WOODS COMMUNITY

Sherrill + Partners + Architects, Inc.
Architecture Planning Inspections Interiors
3613 Milford Mill Rd.
Windsor Mill, MD 21244
443-565-0432

CIVIL/ STRUCTURAL

JC Johnson Consulting Engineers, Inc

TRUE NORTH PLAN NORTH

MEP

3545 MARLBOROUGH WAY COLLEGE PARK, MD 20740

DESIGN TEAM AND OWNER

CENTER

OWNER:

DEPARTMENT OF PUBLIC WORKS CITY OF COLLEGE PARK 9217 51ST AVENUE COLLEGE PARK, MD 20740

CONTRACTOR:

BROUGHTON CONSTRUCTION COMPANY, INC. 4832 NANNIE HELEN BURROUGH AVENUE NE WASHINGTON, DC 20019 (202) 589-0067

ARCHITECT:


SP ARCH, INC. 3613 MILFORD MILL ROAD WINDSOR MILL, MD 21244 (410) 565-0432

CIVIL/ STRUCTURAL ENGINEER:

CIVIL/ STRUCTURAL ENGINEER: 300 EAST JOPPA ROAD SUITE 200 BALTIMORE, MD 21286 (410) 512-4063

MEP ENGINEER:

JOHNSON CONSULTING ENGINEERS 130 W. 25TH STREET BALTIMORE, MD 21218 (410) 235-0057

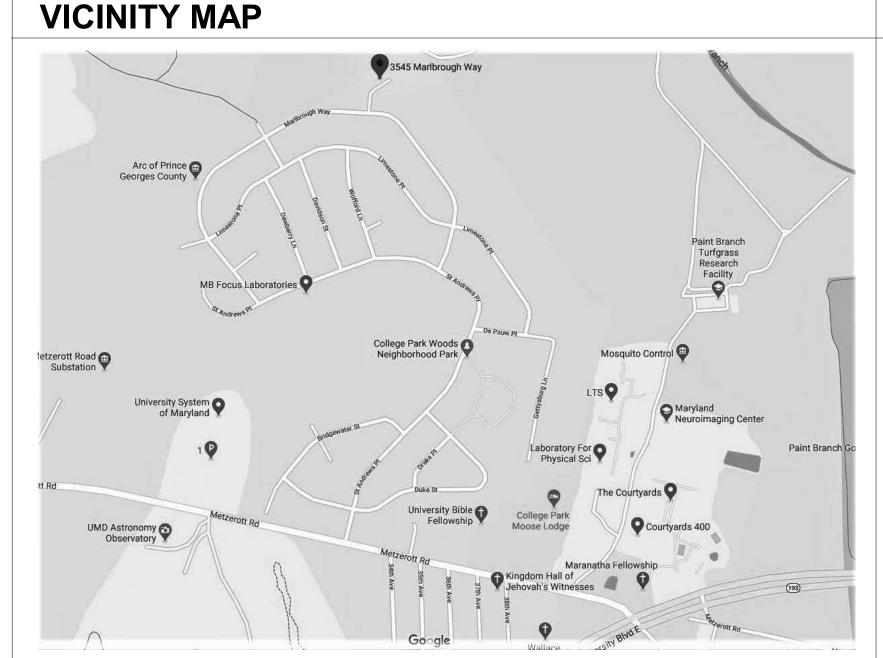

- LIST OF DRAWINGS
- A A A A DOLUTECTUDAL CENEDAL NOTES ADDDEVIATIONS AND SYMPOL
- 1 ARCHITECTURAL GENERAL NOTES, ABBREVIATIONS, AND SYMBOLS
- 2-1 FLOOR PLAN
- 2-2 REFLECTED CEILING PLAN
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- A4-1 BUILDING SECTIONS
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- P0-1 PLUMBING COVER SHEET
- 2-1 GROUND FLOOR PLUMBING
- -1 MECHANICAL COVER SHEET -1 GROUND FLOOR - HVAC
- M3-1 MECHANICAL SCHEDULE
- 14-1 MECHANICAL DETAILS
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CITE MAD



E1-1 ELECTRICAL FLOOR PLAN - NEW WORK
E2-1 LIGHTING FLOOR PLAN - NEW WORK
E3-1 ELECTRICAL RISER DIAGRAMS

GENERAL NOTES AND SPECIFICATIONS

CODE ANALYSIS

	3545 MARLBOROUGH WAY, COLLEGE	PARK, MD, 20740		
PROJECT DESCRIPTIO		NO CONSTRUCTION OF NEW C	OLIVANIA DE PROPERTO	SER SUMPLIES A CHE STOR
			OMMUNITY FACILICITY. THE PROSPO BBY, AND GANG RESTROOM, EXISTIN	
BE SPRINKLERED.				
APPLICABLE CODES:				
	SAFETY CODE AND SUBTITLE 11 PRING L BUILDING CODE AND SUBTITLE 4 PF			
	NAL FIRE ALARM AND SIGNALING CO		ANG COOL	
2014 NFPA 70 NATIO	NAL ELECTRICAL CODE AND SUBTITLE	9 PRINCE GEORGE'S COUNTY E	ELECTRICAL CODE	
	YLAND ACCESSIBILITY CODE			
2010 ADA STANDARI 2015 INTERNATIONA	L MECHANICAL CODE			
2015 INTERNATIONA	L ENERGY CONSERVATION CODE			
			2007	
TOPIC	IBC Requirement	NFPA 101 Requirement	EXISTING TO BE DEMOLISHED	PROPOSED / PROVIDED
Use Group	Section 302	Chapter 6	A-3 / Assembly	A-3 / Assembly
Special	N/A	700	***	
Requirements (IBC Chapter 4)				
Construction Type	Table 604	NFPA 220	III-B/ II-000	V-B / V-000
Building Height	Table 504.3 60' S	N/A	Existing 12' +/-	16'
Number of Stories	Table 504.4	Table 12.1.6	1	1
Total GSF	2 S Table 506.2	2 max.		
Building Area	24,000 SF S1	N/A	Overall 1,400 SF +/- (A-3)	2,442 SF (A-3)
Building Area by Floor	First Floor: 2,442 SF			
(if appplicable)			-10	
Unlimited Area Building	Section 507	N/A	N/A	N/A
Building Required Separation				
for Mixed Use	Table 508.4 N/A	Table 6.1.14.4.1(a) N/A	N/A	N/A
Occupancy	N/A	N/A		=//=
Incidental Use Areas	Table 509	N/A	N/A	N/A
Fire Separation	Table 602	N/A	N/A	0
Distance Distance	2122418-2002	N/A	IVA.	y.
TOPIC	AND EGRESS REQUIREMENTS IBC Requirement	NFPA 101 Requirement	EXISTING	PROPOSED / PROVIDED
Occupant Loads	Table 1004.1.2	Table 7.3.1.2	N/A	298 - Standing Room Only
	Section 1005.3.1 and 1009.3	10010 7.3.4.2	20000	
Stair Width	.3" per OCC	Table 7.2.1.7	N/A	N/A
Stair Rated Enclosure	Section 1023.2	Table 7.2.1.7	N/A	N/A
0 - "W 21"	5-41-1000.5	C-12-12	101	
Area of Refuge	Section 1009.6	Section 7.2.12	N/A	N/A
Door Width	Section 1005.3.2 .2" per OCC NS	Chapter 7 & 12	N/A	36" Min.
DOOF WIDTH	.15" per OCC S	Chapter / & 12	N/A	36 IVIII.
Carridor Width	Section 1005.3.2 .15" / OCC	Chapter 7 & 12	N/A	44" Min.
Number of Fults	Section 1006.3.1	Chapter 7 & 12	N/A	3
Number of Exits	2 min.	2 min.	N/A	3
TOPIC	STEM REQUIREMENTS IBC Requirement	NFPA 101 Requirement	EXISTING	PROPOSED / PROVIDED
Automatic	Section 903 (Not Required)	Secion 12.3.5	500	
Sprinklers	Required per HoCo Amendments	Not Required	N/A	To be Provided
Portable Fire	Section 906		N/A	Refer to Life Safety Plan
Extinguishers Fire Alarm System	Required Section 907		N/A	for Locations To be Provided
EXIT ACCESS	Section 507		N/A	10 De 710Video
TOPIC	IBC Requirement	NFPA 101 Requirement	EXISTING	PROPOSED / PROVIDED
Max Common Path	Table 1006.2.1	Section 12.2.5.1.2	N/A	Refer to Life Safety Plan
of Travel	75' S	75' for > 50 OCC	N/A	Refer to Life Safety Plan
Max Exit Access	Table 1017.2	Section 12.2.6.2	N/A	Refer to Life Safety Plan
Travel Distance Max Dead	250' S Table 1020.2	250' 5 12.2.5.1.3		
End Distance	20' Section 1007 1 1	20'	N/A	Refer to Life Safety Plan
Exit Remateness	Section 1007.1.1 1/3 Distance	Section 7.5.1.3.3 1/3 Distance	N/A	Refer to Life Safety Plan
INTERIOR FINISHES				
TOPIC	in a north control	NFPA 101 Requirement	EXISTING	PROPOSED / PROVIDED
	IBC Requirement		1	Charles C
Class	Table 803.11 Note E: C	Chapter 10	N/A	Class C
10-11-1-11	Table 803.11 Note E: C		1	PROPOSED / PROVIDED
Class CORRIDOR REQUIRE TOPIC Corridor Fire-	Table 803.11 Note E: C MENTS IBC Requirement Table 1020.1	Chapter 10 NFPA 101 Requirement Section 12.3.6	N/A	
Class CORRIDOR REQUIRE TOPIC Corridor Fire- Resistant Rating	Table 803.11 Note E: C MENTS IBC Requirement	Chapter 10 NFPA 101 Requirement	N/A EXISTING N/A	PROPOSED / PROVIDED N/A
Class CORRIDOR REQUIRE TOPIC Corridor Fire- Resistant Rating Corridor Width	Table 803.11 Note E: C MENTS IBC Requirement Table 1020.1 0 HR	Chapter 10 NFPA 101 Requirement Section 12.3.6 0 HR	N/A EXISTING	PROPOSED / PROVIDED
Class CORRIDOR REQUIRE TOPIC Corridor Fire- Resistant Rating Corridor Width PANIC HARDWARE	Table 803.11 Note E: C MENTS IBC Requirement Table 1020.1 0 HR Table 1020.2 44"	Chapter 10 NFPA 101 Requirement Section 12,3.6 0 HR Section 12,2.3.8 44"	N/A EXISTING N/A N/A	PROPOSED / PROVIDED N/A N/A
Class CORRIDOR REQUIRE TOPIC Corridor Fire- Resistant Rating Carridor Width PANIC HARDWARE TOPIC	Table 803.11 Note E: C MENTS IBC Requirement Table 1020.1 0 HR Table 1020.2	Chapter 10 NFPA 101 Requirement Section 12.3.6 0 HR Section 12.2.3.8	N/A EXISTING N/A N/A EXISTING	PROPOSED / PROVIDED N/A N/A PROPOSED / PROVIDED
Class CORRIDOR REQUIRE TOPIC Corridor Fire- Resistant Rating Corridor Width PANIC HARDWARE TOPIC Location	Table 803.11 Note E: C MENTS IBC Requirement Table 1020.1 0 HR Table 1020.2 44" IBC Requirement (Table 1010.1.10) All Egress Doors	Chapter 10 NFPA 101 Requirement Section 12.3.6 0 HR Section 12.2.3.8 44" NFPA 101 Requirement	N/A EXISTING N/A N/A	PROPOSED / PROVIDED N/A N/A PROPOSED / PROVIDED
Class CORRIDOR REQUIRE TOPIC Corridor Fire- Resistant Rating Corridor Width PANIC HARDWARE TOPIC Location	Table 803.11 Note E: C MENTS IBC Requirement Table 1020.1 0 HR Table 1020.2 44" IBC Requirement (Table 1010.1.10) All Egress Doors	Chapter 10 NFPA 101 Requirement Section 12.3.6 0 HR Section 12.2.3.8 44" NFPA 101 Requirement {7.2.1.7}	N/A EXISTING N/A N/A EXISTING	PROPOSED / PROVIDED N/A N/A PROPOSED / PROVIDED Refer to Life Safety Plan and Hardware Schedule
Class CORRIDOR REQUIRE TOPIC Corridor Fire- Resistant Roting Corridor Width PANIC HARDWARE TOPIC Location BUILDING FIRE RATIN TOPIC Construction Type:	Table 803.11 Note E: C MENTS IBC Requirement Table 1020.1 0 HR Table 1020.2 44" IBC Requirement (Table 1010.1,10) All Egress Doors	Chapter 10 NFPA 101 Requirement Section 12.3.6 0 HR Section 12.2.3.8 44" NFPA 101 Requirement {7.2.1.7} All Egress Doors	N/A EXISTING N/A N/A EXISTING N/A	PROPOSED / PROVIDED N/A N/A PROPOSED / PROVIDED Refer to Life Safety Plan and
Class CORRIDOR REQUIRE TOPIC Corridor Fire- Resistant Roting Corridor Width PANIC HARDWARE TOPIC Location BUILDING FIRE RATIN TOPIC Construction Type: Primary Structural	Table 803.11 Note E: C MENTS IBC Requirement Table 1020.1 0 HR Table 1020.2 44" IBC Requirement (Table 1010.1.10) All Egress Doors IBC Table 601 & 602	Chapter 10 NFPA 101 Requirement Section 12.3.6 0 HR Section 12.2.3.8 44" NFPA 101 Requirement (7.2.1.7) All Egress Doors NFPA 101 Table 8.3.4.2	N/A EXISTING N/A N/A EXISTING N/A EXISTING	PROPOSED / PROVIDED N/A N/A PROPOSED / PROVIDED Refer to Life Safety Plan and Hardware Schedule PROPOSED / PROVIDED
Class CORRIDOR REQUIRE TOPIC Corridor Fire- Resistant Roting Corridor Width PANIC HARDWARE TOPIC Location BUILDING FIRE RATIN TOPIC Construction Type:	Table 803.11 Note E: C MENTS IBC Requirement Table 1020.1 0 HR Table 1020.2 44" IBC Requirement (Table 1010.1.10) All Egress Doors IBC Table 601 & 602 V-B 0	Chapter 10 NFPA 101 Requirement Section 12,3.6 0 HR Section 12,2.3.8 44" NFPA 101 Requirement (7,2,1,7) All Egress Doors NFPA 101 Table 8,3,4.2 V-000 0	N/A EXISTING N/A N/A EXISTING N/A EXISTING N/A N/A N/A	PROPOSED / PROVIDED N/A N/A PROPOSED / PROVIDED Refer to Life Safety Plan and Hardware Schedule PROPOSED / PROVIDED V-B / V-000
Class CORRIDOR REQUIRED TOPIC Corridor Fire- Resistant Rating Corridor Width PANIC HARDWARE TOPIC Location BUILDING FIRE RATIN TOPIC Construction Type: Primary Structural Frame Exterior / Interior Bearing Walls	Table 803.11 Note E: C MENTS IBC Requirement Table 1020.1 0 HR Table 1020.2 44" IBC Requirement (Table 1010.1.10) All Egress Doors NGS IBC Table 601 & 602 V-B	Chapter 10 NFPA 101 Requirement Section 12.3.6 0 HR Section 12.2.3.8 44" NFPA 101 Requirement (7.2.1.7) All Egress Doors NFPA 101 Table 8.3.4.2 V-000	N/A EXISTING N/A N/A EXISTING N/A EXISTING N/A	PROPOSED / PROVIDED N/A N/A PROPOSED / PROVIDED Refer to Life Safety Plan and Hardware Schedule PROPOSED / PROVIDED V-B / V-000
Class CORRIDOR REQUIRED TOPIC Corridor Fire- Resistant Rating Corridor Width PANIC HARDWARE TOPIC Location BUILDING FIRE RATIN TOPIC Construction Type: Primary Structural Frame Exterior / Interior Bearing Walls Exterior / Interior	Table 803.11 Note E: C MENTS IBC Requirement Table 1020.1 0 HR Table 1020.2 44" IBC Requirement (Table 1010.1.10) All Egress Doors IBC Table 601 & 602 V-B 0	Chapter 10 NFPA 101 Requirement Section 12,3.6 0 HR Section 12,2.3.8 44" NFPA 101 Requirement (7,2,1,7) All Egress Doors NFPA 101 Table 8,3,4.2 V-000 0	N/A EXISTING N/A N/A EXISTING N/A EXISTING N/A N/A N/A	PROPOSED / PROVIDED N/A N/A PROPOSED / PROVIDED Refer to Life Safety Plan and Hardware Schedule PROPOSED / PROVIDED V-B / V-000
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Class CORRIDOR REQUIRE TOPIC Corridor Fire- Resistant Rating Corridor Width PANIC HARDWARE TOPIC Location BUILDING FIRE RATIN TOPIC Construction Type: Primary Structural Frame Exterior / Interior Bearing Walls Exterior Walls Flaar Construction Roof Construction	Table 803.11 Note E: C MENTS IBC Requirement Table 1020.1 0 HR Table 1020.2 44" IBC Requirement (Table 1010.1.10) All Egress Doors NGS IBC Table 601 & 602 V-B 0 0 0 0 0	Chapter 10 NFPA 101 Requirement Section 12.3.6 0 HR Section 12.2.3.8 44" NFPA 101 Requirement (7.2.1.7) All Egress Doors NFPA 101 Table 8.3.4.2 V-000 0 0 0 0 0	N/A EXISTING N/A N/A EXISTING N/A EXISTING N/A N/A N/A N/A N/A N/A N/A	PROPOSED / PROVIDED N/A N/A PROPOSED / PROVIDED Refer to Life Safety Plan and Hardware Schedule PROPOSED / PROVIDED V-B / V-000 0 0 0 0 0
Class CORRIDOR REQUIRE TOPIC Corridor Fire- Resistant Rating Corridor Width PANIC HARDWARE TOPIC Location BUILDING FIRE RATIN TOPIC Construction Type: Primary Structural Frame Exterior / Interior Bearing Walls Exterior / Interior Non-Bearing Walls Floor Construction Roof Construction Fire Walls	Table 803.11 Note E: C MENTS IBC Requirement Table 1020.1 0 HR Table 1020.2 44" IBC Requirement (Table 1010.1.10) All Egress Doors NGS IBC Table 601 & 602 V-B 0 0 0 0 N/A	Chapter 10 NFPA 101 Requirement Section 12.3.6	N/A EXISTING N/A N/A EXISTING N/A EXISTING N/A N/A N/A N/A N/A N/A N/A N	PROPOSED / PROVIDED N/A N/A PROPOSED / PROVIDED Refer to Life Safety Plan and Hardware Schedule PROPOSED / PROVIDED V-B / V-000 0 0 0 0 0 N/A
Class CORRIDOR REQUIRE TOPIC Corridor Fire- Resistant Rating Corridor Width PANIC HARDWARE TOPIC Location BUILDING FIRE RATIN TOPIC Construction Type: Primary Structural Frame Exterior / Interior Bearing Walls Exterior Walls Flaar Construction Roof Construction	Table 803.11 Note E: C MENTS IBC Requirement Table 1020.1 0 HR Table 1020.2 44" IBC Requirement (Table 1010.1.10) All Egress Doors NGS IBC Table 601 & 602 V-B 0 0 0 0 0	Chapter 10 NFPA 101 Requirement Section 12.3.6 0 HR Section 12.2.3.8 44" NFPA 101 Requirement (7.2.1.7) All Egress Doors NFPA 101 Table 8.3.4.2 V-000 0 0 0 0 0	N/A EXISTING N/A N/A EXISTING N/A EXISTING N/A N/A N/A N/A N/A N/A N/A	PROPOSED / PROVIDED N/A N/A PROPOSED / PROVIDED Refer to Life Safety Plan an Hardware Schedule PROPOSED / PROVIDED V-B / V-000 0 0 0 0
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Class CORRIDOR REQUIRED TOPIC Corridor Fire- Resistant Rating Corridor Width PANIC HARDWARE TOPIC Location BUILDING FIRE RATIN TOPIC Construction Type: Primary Structural Frame Exterior / Interior Bearing Walls Exterior / Interior Non-Bearing Walls Floor Construction Roof Construction Fire Walls Vertical Exit Enclosures Exit Passageways	Table 803.11 Note E: C MENTS IBC Requirement Table 1020.1 0 HR Table 1020.2 44" IBC Requirement (Table 1010.1.10) All Egress Doors IBC Table 601 & 602 V-B 0 0 0 N/A N/A N/A	Chapter 10 NFPA 101 Requirement Section 12.3.6	N/A EXISTING N/A N/A EXISTING N/A EXISTING N/A N/A N/A N/A N/A N/A N/A N	PROPOSED / PROVIDED N/A N/A PROPOSED / PROVIDED Refer to Life Safety Plan and Hardware Schedule PROPOSED / PROVIDED V-B / V-000 0 0 0 0 N/A N/A
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Class CORRIDOR REQUIRE TOPIC Corridor Fire- Resistant Rating Corridor Width PANIC HARDWARE TOPIC Location BUILDING FIRE RATIN TOPIC Construction Type: Primary Structural Frame Exterior / Interior Bearing Walls Exterior / Interior Non-Bearing Walls Flaar Construction Roof Construction Roof Construction Fire Walls Vertical Exit Enclosures Exit Passageways PLUMBING FIXTURES TOPIC Men's WC's	Table 803.11 Note E: C MENTS IBC Requirement Table 1020.1 0 HR Table 1020.2 44" IBC Requirement (Table 1010.1.10) All Egress Doors NGS IBC Table 601 & 602 V-B 0 0 0 0 N/A N/A N/A N/A N/A N/A N/A N/A S IBC Table 2902.1 1 per 125 (149 occ)= 2 min.	Chapter 10 NFPA 101 Requirement Section 12.3.6	N/A EXISTING N/A N/A EXISTING N/A N/A N/A N/A N/A N/A N/A N	PROPOSED / PROVIDED N/A N/A N/A PROPOSED / PROVIDED Refer to Life Safety Plan and Hardware Schedule PROPOSED / PROVIDED V-B / V-000 0 0 0 0 N/A N/A N/A
Class CORRIDOR REQUIRE TOPIC Corridor Fire- Resistant Rating Corridor Width PANIC HARDWARE TOPIC Location BUILDING FIRE RATIN TOPIC Construction Type: Primary Structural Frame Exterior / Interior Bearing Walls Exterior / Interior Non-Bearing Walls Flaor Construction Roof Construction Roof Construction Fire Walls Vertical Exit Enclosures Exit Passageways PLUMBING FIXTURES TOPIC Men's WC's Women's WC's	Table 803.11 Note E: C MENTS IBC Requirement Table 1020.1 0 HR Table 1020.2 44" IBC Requirement (Table 1010.1.10) All Egress Doors NGS IBC Table 601 & 602 V-B 0 0 0 0 N/A N/A N/A N/A N/A S IBC Table 2902.1 1 per 125 (149 occ)= 2 min. 1 per 65 (149 occ)= 3 min.	Chapter 10 NFPA 101 Requirement Section 12.3.6	N/A EXISTING N/A N/A EXISTING N/A N/A N/A N/A N/A N/A N/A N	PROPOSED / PROVIDED N/A N/A PROPOSED / PROVIDED Refer to Life Safety Plan and Hardware Schedule PROPOSED / PROVIDED V-B / V-000 0 0 0 0 N/A N/A N/A PROPOSED / PROVIDED 1 ADA WC, 4 WC
Class CORRIDOR REQUIRE TOPIC Corridor Fire- Resistant Rating Corridor Width PANIC HARDWARE TOPIC Location BUILDING FIRE RATIN TOPIC Construction Type: Primary Structural Frame Exterior / Interior Bearing Walls Exterior / Interior Non-Bearing Walls Flaar Construction Roof Construction Roof Construction Fire Walls Vertical Exit Enclosures Exit Passageways PLUMBING FIXTURES TOPIC Men's WC's	Table 803.11 Note E: C MENTS IBC Requirement Table 1020.1 0 HR Table 1020.2 44" IBC Requirement (Table 1010.1.10) All Egress Doors NGS IBC Table 601 & 602 V-B 0 0 0 0 N/A N/A N/A N/A N/A N/A N/A N/A S IBC Table 2902.1 1 per 125 (149 occ)= 2 min.	Chapter 10 NFPA 101 Requirement Section 12.3.6	N/A EXISTING N/A N/A EXISTING N/A N/A N/A N/A N/A N/A N/A N	PROPOSED / PROVIDED N/A N/A PROPOSED / PROVIDED Refer to Life Safety Plan and Hardware Schedule PROPOSED / PROVIDED V-B / V-000 0 0 0 0 N/A N/A N/A PROPOSED / PROVIDED

BUILDING CODE ANALYSIS

PROFESSIONAL CERTIFICATION:

prepared or approved by me, and that I am a duly licensed architect under the laws of the State of

expiration date __

COLLEGE PARK DESIGN-BUILD COMMUNITY

SPACE

3545 MARLBOROUGH WAY COLLEGE PARK, MD 20740

COVER SHEET

DRAWING NO.

G0-1

\$CALE: CP JOB NO.: CP-19-05 \$PA JOB NO.: 19-022

DESIGNED BY: Designer
DRAWN BY: Author

PERMIT SET

DRAWN BY: Author

CHECKED BY: Checker

APPROVED BY: Approver

STANDARDS AND REGULATIONS

- 1) CONTRACTOR SHALL PERFORM ALL WORK IN CONFORMANCE WITH APPLICABLE BUILDING CODES, REGULATIONS, ORDINANCES, UTILITY PROVIDER REQUIREMENTS, AND SIMILAR STANDARDS.
- 2) CONTRACTOR SHALL OBTAIN ALL REQUIRED INSPECTIONS OF THE WORK. CONTRACTOR SHALL REGULARLY UPDATE OWNER AND ARCHITECT REGARDING THE STATUS OF INSPECTIONS.
- 3) CONTRACTOR SHALL COORDINATE WORK WITH APPLICABLE UTILITY PROVIDERS
- 4) CONTRACTOR SHALL BE FAMILIAR WITH REQUIREMENTS AND CONSTRUCTION SHALL BE IN COMPLIANCE WITH REFERENCED FIRE-RATED ASSEMBLY TESTS AND STANDARDS.
- 5) SHOULD THE CONTRACTOR ENCOUNTER ANY HAZARDOUS MATERIAL, CONTRACTOR TO STOP WORK AND NOTIFY OWNER.

ADMINISTRATION OF THE WORK:

- 1) CONTRACTOR SHALL BE SOLELY RESPONSIBLE FOR THE MEANS, METHODS, AND SEQUENCES OF CONSTRUCTION AND DIMENSIONS.
- 2) CONTRACTOR SHALL BE SOLELY RESPONSIBLE FOR THE SAFETY OF ALL CONSTRUCTION PERSONNEL AND AUTHORIZED VISITORS AT THE SITE.
- 3) CONTRACTOR SHALL BECOME FULLY ACQUAINTED WITH CONDITIONS RELATED TO THE WORK. ANY KNOWN DISCREPANCIES BETWEEN THE DOCUMENTS AND THE ACTUAL CONDITIONS SHALL BE REPORTED TO THE ARCHITECT FOR RESOLUTION PRIOR TO PROCEEDING WITH WORK RELATED TO THE DISCREPANCY.
- 4) CONTRACTOR SHALL REMOVE AND PROPERLY DISPOSE OF ALL CONSTRUCTION AND DEMOLITION DEBRIS. CONTRACTOR SHALL OBTAIN APPROVAL OF OWNER FOR DETAILS RELATING TO THE REMOVAL OF TRASH, INCLUDING SUCH ISSUES AS PATH OF TRAVEL, LOCATION OF CHUTES AND DUMPSTERS, ETC., PRIOR TO REMOVAL OF DEBRIS. CONTRACTOR SHALL CLEAN AND REPAIR ANY DAMAGES TO EXISTING ITEMS SOILED OR DAMAGED BY THE DEBRIS REMOVAL PROCESS. IF CLEANING AND/OR REPAIR DOES NOT RETURN ITEMS TO ORIGINAL CONDITION CONTRACTOR SHALL INSTALL NEW ITEMS.
- 5) CONTRACTOR SHALL BECOME FAMILIAR WITH AND COMPLY WITH OWNER'S PROCEDURES FOR MAINTAINING A SECURE SITE AND BUILDING.
- 6) EACH INSTALLER SHALL EXAMINE ALL SUBSTRATE CONDITIONS AND/OR SITE CONDITIONS WHICH AFFECT THE QUALITY OF EACH PRODUCT TO BE INSTALLED. IF ANY CONDITIONS EXIST WHICH WILL HAVE A DETRIMENTAL EFFECT ON THE QUALITY OF THE INSTALLATION, THE INSTALLER SHALL IMMEDIATELY NOTIFY THE CONTRACTOR. INSTALLATION SHALL NOT PROCEED UNTIL THE UNSATISFACTORY CONDITIONS ARE CORRECTED. INSTALLATION SHALL SIGNIFY ACCEPTANCE OF THE CONDITIONS.
- 7) CONTRACTOR SHALL MAINTAIN RECORD DRAWINGS ON THE SITE AT ALL TIMES.
- 8) CONTRACTOR SHALL BE RESPONSIBLE FOR ENSURING COORDINATION EFFORTS OF ALL SUBCONTRACTORS.
- 9) CONTRACTOR SHALL LAY OUT ALL WORK AS SOON AS POSSIBLE. ANY DISCREPANCIES SHALL BE REPORTED TO THE OWNER FOR RESOLUTION PRIOR TO PROCEEDING WITH THE WORK IN QUESTION.

USE OF CONSTRUCTION DOCUMENTS:

- 1) DO NOT SCALE DRAWINGS. ONLY WRITTEN DIMENSIONS OR KEYED NOTES SHALL BE USED. CONTACT ENGINEER IF CLARIFICATION OR ADDITIONAL INFORMATION IS REQUIRED.
- 2) THE DRAWINGS ARE SCHEMATIC IN NATURE. MODIFICATIONS IN DUCTS, PIPING, CONDUIT AND WIRING MAY BE REQUIRED TO ACCOMMODATE ACTUAL FIELD CONDITIONS.
- 3) DRAWINGS SHALL NOT BE REPRODUCED FOR SUBMITTALS
- 4) DIMENSIONS ARE AS FOLLOWS UNLESS NOTED OTHERWISE:
- A) TO FACE OF GYPSUM WALLBOARD.
- B) TO CENTERLINE OF COLUMNS.
- C) TO TOP OF FLOOR SLAB.
- D) TO BOTTOM OF FINISHED CEILING.
- E) TO FACE OF MASONRY, CONCRETE, AND/OR SIDING.

DEFINITIONS:

- 1) "ALIGN" AS USED IN THESE DOCUMENTS SHALL MEAN TO ACCURATELY LOCATE FINISH FACES IN THE SAME PLANE AND/OR TO INSTALL NEW CONSTRUCTION ADJACENT TO EXISTING CONSTRUCTION WITHOUT ANY VISIBLE JOINTS OR SURFACE IRREGULARITIES.
- 2) "CLEAR" AS USED IN THESE DOCUMENTS SHALL MEAN THAT THE CONDITION IS NOT ADJUSTABLE WITHOUT APPROVAL OF THE ARCHITECT. CLEAR DIMENSIONS ARE TYPICALLY TO FINISH FACE.
- 3) "MAXIMUM" OR "MAX" AS USED IN THESE DOCUMENTS SHALL MEAN THAT THE CONDITION IS SLIGHTLY ADJUSTABLE BUT MAY NOT VARY TO A DIMENSION OR QUANTITY GREATER THAN THAT SHOWN WITHOUT APPROVAL OF THE ENGINEER.
- 4) "MINIMUM" OR "MIN" AS USED IN THESE DOCUMENTS SHALL MEAN THAT THE CONDITION IS SLIGHTLY ADJUSTABLE BUT MAY NOT VARY TO A DIMENSION OR QUANTITY LESS THAN THAT SHOWN WITHOUT APPROVAL OF THE ENGINEER.
- 5) "TYPICAL" AS USED IN THESE DOCUMENTS SHALL MEAN THAT THE CONDITION OR DIMENSION IS THE SAME OR REPRESENTATIVE FOR SIMILAR CONDITIONS THROUGHOUT.
- 6) "+-" AS USED IN THESE DOCUMENTS SHALL MEAN THAT THE DIMENSION OR QUALITY IS SLIGHTLY ADJUSTABLE TO ACCOMMODATE ACTUAL CONDITIONS. FIELD VERIFICATION AND COORDINATION WITH OTHER ELEMENTS MIGHT BE NECESSARY.

DRAWING KE	Y				S	YMBOLS				
SIM A101	BUILDING SECTI	ION B	Ref 1 A101 1 To	EXTERIOR ELEVATION		CJ	CONTROL JOIN	NT		EXPANSION JOINT CONCRETE COMPACTED GRAVEL
SIM (A101)	CALLOUT		(D1)	KEYNOTE NUMBER		* • •	WELDED WIRE REINFORCING E	BARS		SUBGRADE EXISTING PAVEMENT
1 View Name A102 A101 1/8" = 1'-0"	VIEW TITLE		101)	DOOR NUMBER			NEW CONCRET	E SLAB		
A101 TO	INTERIOR ELEVA	ATION	(1t)	WINDOW TAG						
<u>(1)</u>	PARTITION TYPE	Ē	P#	ROOM TAG						
ACP ACOUSTIC CEIL AFF ABOVE FINISH ALUM ALUMINUM AUTO AUTOMATIC ABV ABOVE BC BOTTOM OF CU B.O. BOTTOM OF BLK BLOCK BRG BEARING BLKG BLOCKING BD BOARD BLDG BUILDING CL/ CENTERLINE CLO. CLOSET CLG CEILING CONC CONCRETE CONT CONTINUOUS CONTR CONTRACTOR CONTR CONTRACTOR CONTROL JOIN CRS COURSE DIAM DIAMETER DOWN DTL DETAIL DWG DRAWING EA EACH ETR EXISTING TO R EWC ELECTRIC WATE EXP EXPANSION EX EXTERIOR EXT EXTERIOR EQUIP EQUIPMENT ELEC ELECTRIC ELE	ING PANEL FLOOR JRB SONRY UNIT T	F/ FE FER FTG GALV GC GYPB HTCW HTVAC HM INST JAN LAW LH LTWT LVR MAX MER MIN	FACE OF FIRE EXTINGUI FIRE EXTINGUI FIRE EXTINGUI FLOOR FOOTING GAUGE GALVANIZED GENERAL CON GLASS GYPSUM GYPSUM WALL HEIGHT HANDICAPPED HARDWARE HEATING HEATING/ VEN AIRCONDITION HOLLOW META INSULATION INTERIOR JOINT JANITOR LAMINATE LAVATORY LEFT HAND LIGHT LIGHTWEIGHT LOUVER MASONRY MAXIMUM MECHANICAL MANUFACTURI MINIMUM	SHER CABINET TRACTOR BOARD TILATING/ ING AL	MROI MS MTL NA NO NOM NTS NIC OPC OPP PLAM PLWYD PNL PREF PR PT PCF QT RAD REINF RHW RM RO SIM	MAINTENANCE AND OPERATION METAL STUD METAL NOT APPLICATE NUMBER NOMINAL NOT TO SCALE NOT IN CONTR OPENING ON CENTER OVERHEAD OPPOSITE PLATE PLASTIC LAMIN PLYWOOD PANEL PREFABRICAT PERFORATED PAIR PAINT POUNDS PER QUARRY TILE RISER RADIUS ROOF DRAIN REFERENCE REINFORCED RIGHT HAND RIGHT OR WAY ROOM ROUGH OPENI	ON ITEMS BLE ERACT NATE CUBIC FOOT	SPEC SS S.S. STN STD SUSP TC THK TYP T.O. TEMP UNO VERT VIF WH W/O WWF	SPECIFICATION STAINLESS STEEL SATIN STAINLESS STAIN STANDARD SUSPENDED TOP OF CURB THICK TYPICAL TREAD TOP OF TEMPERED/ TEMP UNFINISHED UNLESS NOTED OF VERTICAL VERIFY IN FIELD WOOD WATER HEATER WITHOUT WELDED WIR	



ARCHITECT

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Windsor Mill, MD 21244 443-565-0432

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prepared or approved by me, and that I am a duly licensed architect

COLLEGE PARK

DESIGN-BUILD

COMMUNITY

SPACE

3545 MARLBOROUGH

COLLEGE PARK, MD 20740

under the laws of the State of

expiration date ___

A0-1

SCALE: As indicated


DRAWING NO.

CP JOB NO.: CP-19-05
SPA JOB NO.: 19-022
DATE: 11/11/2020
DESIGNED BY: Designer
DRAWN BY: Author

CHECKED BY: Checker

APPROVED BY: Approver

PERMIT SET

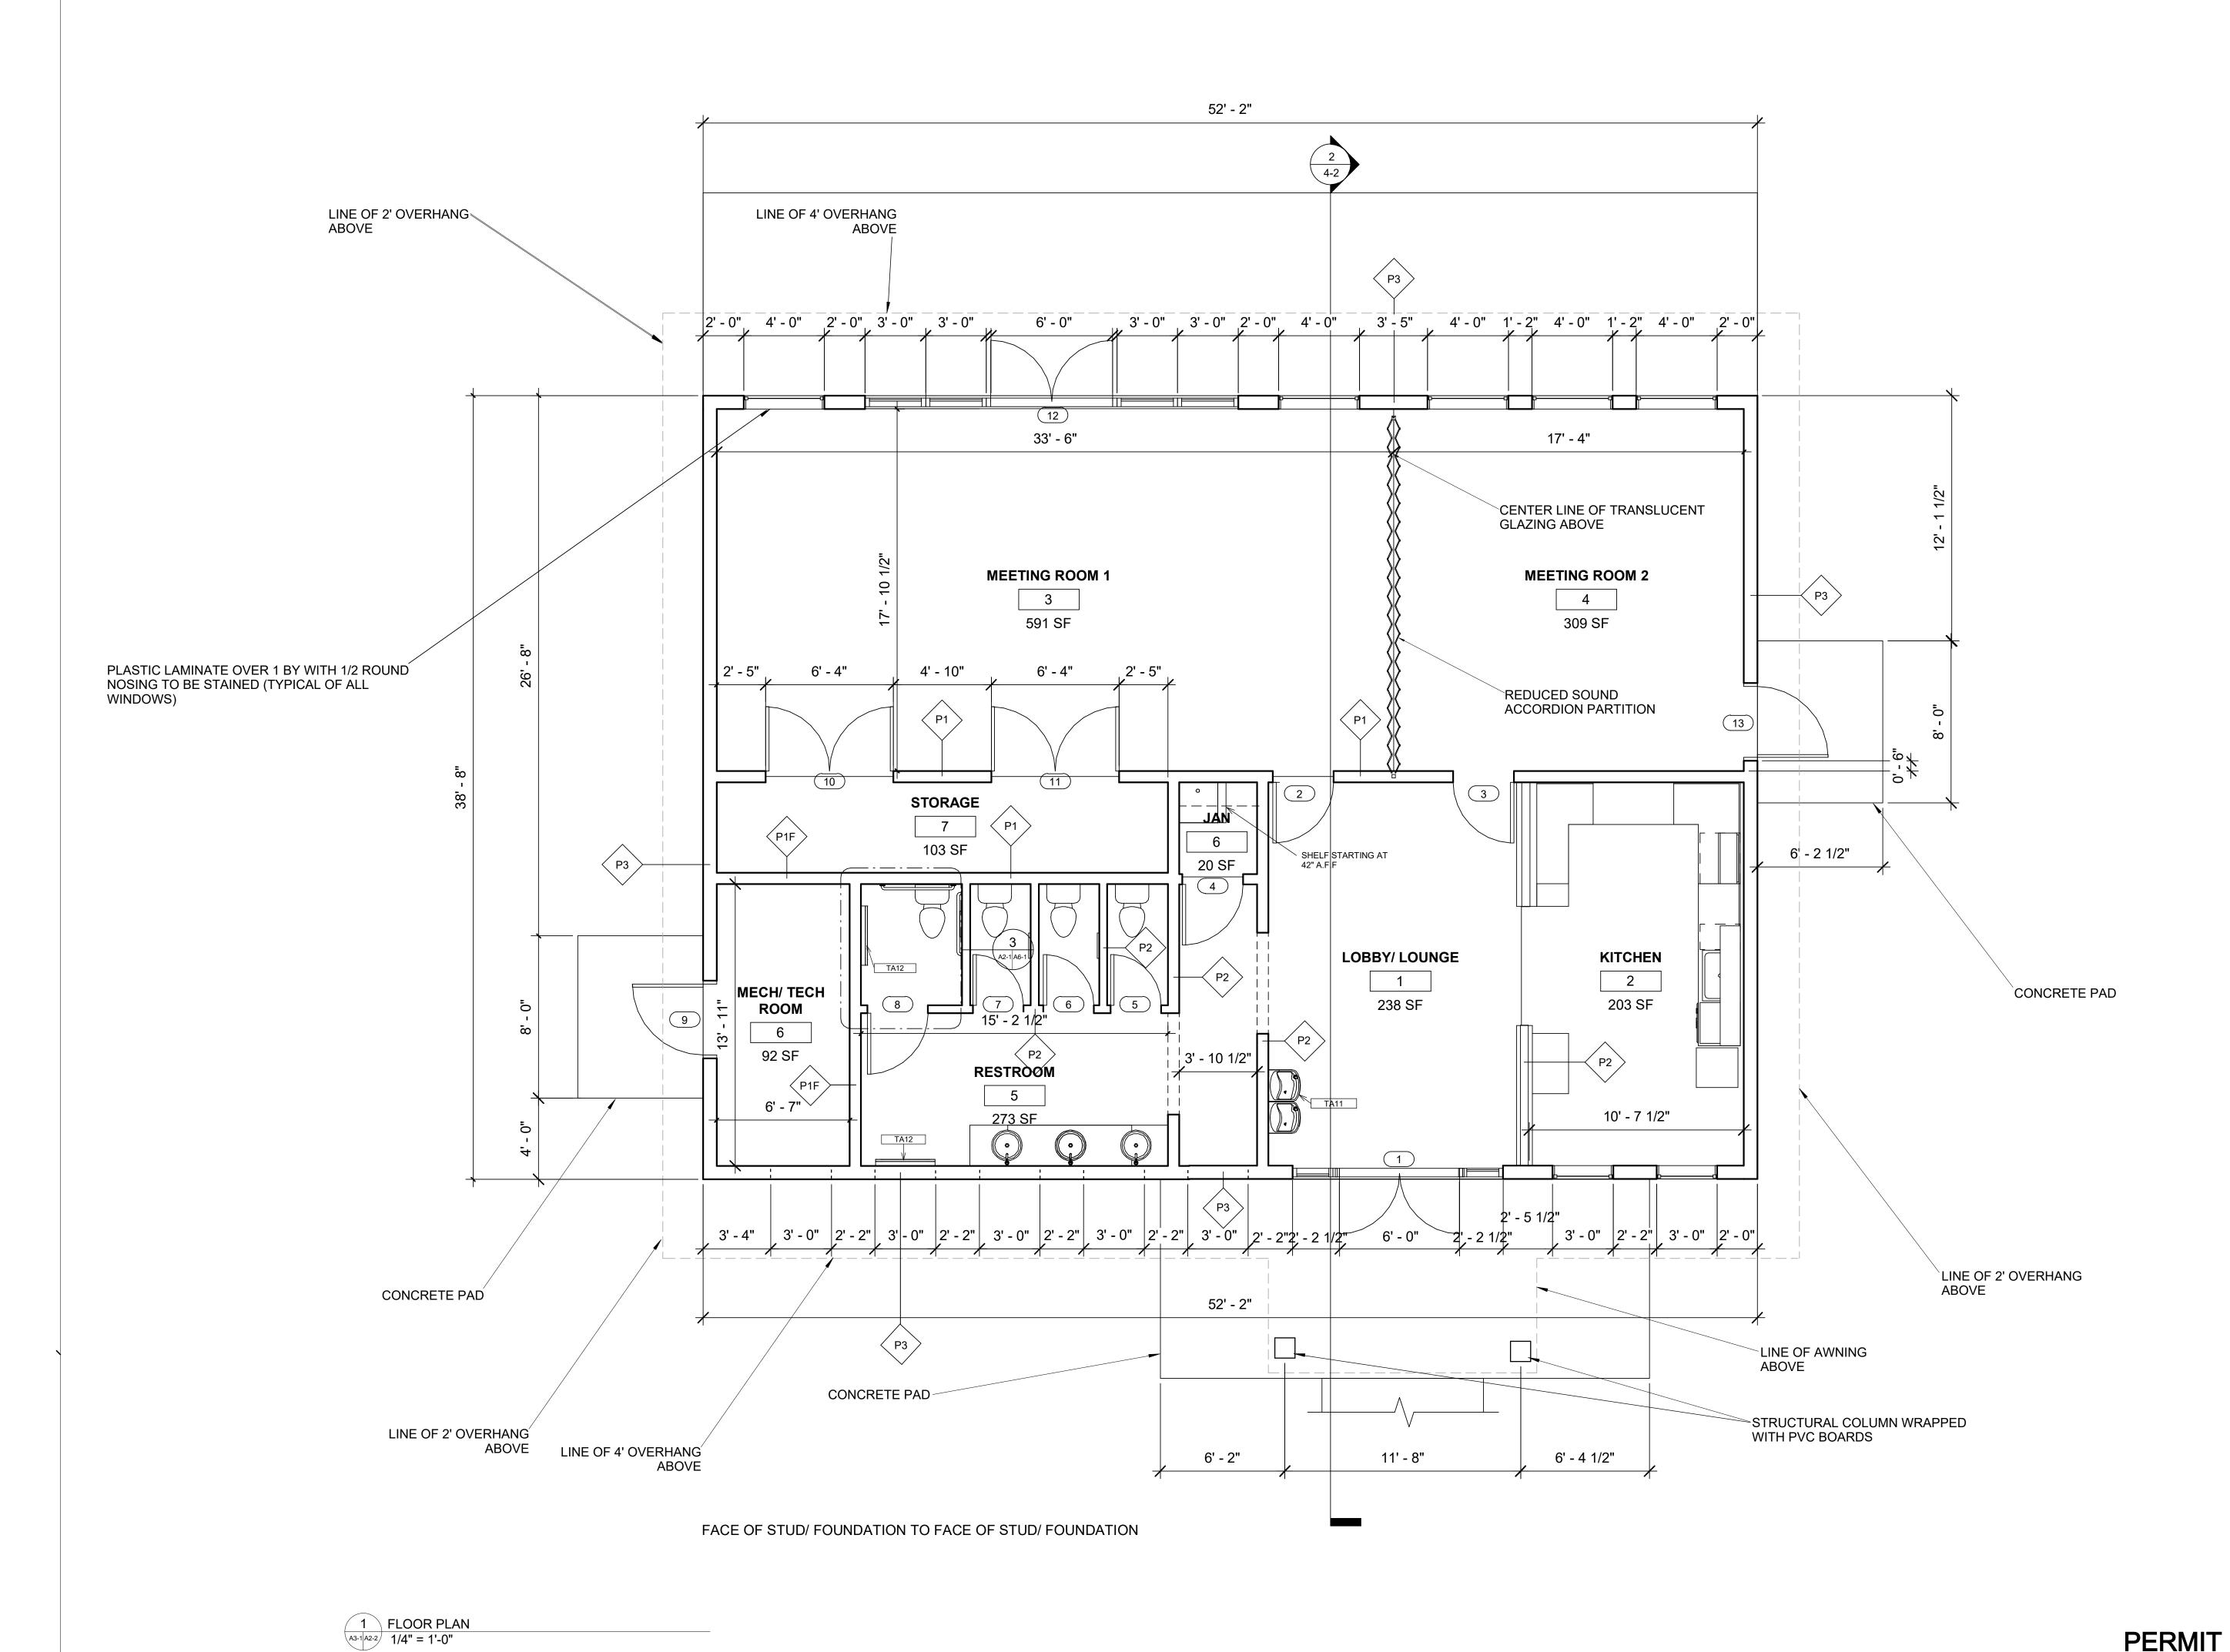


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Je Johnson Consulting Engineers, Inc. 130 W. 25th Street Baltimore, Maryland 21218 Tel: (410) 235-0057, Fax: (410) 235-0946 Email: info@jcengineers.net

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COLLEGE PARK DESIGN-BUILD COMMUNITY **SPACE**


3545 MARLBOROUGH WAY COLLEGE PARK, MD 20740

DRAWING NO.

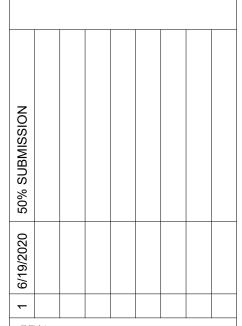A2-1

SCALE: As indicated CP JOB NO.: CP-19-05 SPA JOB NO.: 19-022 DATE: 11/11/2020

DESIGNED BY: Designer DRAWN BY: Author CHECKED BY: Checker

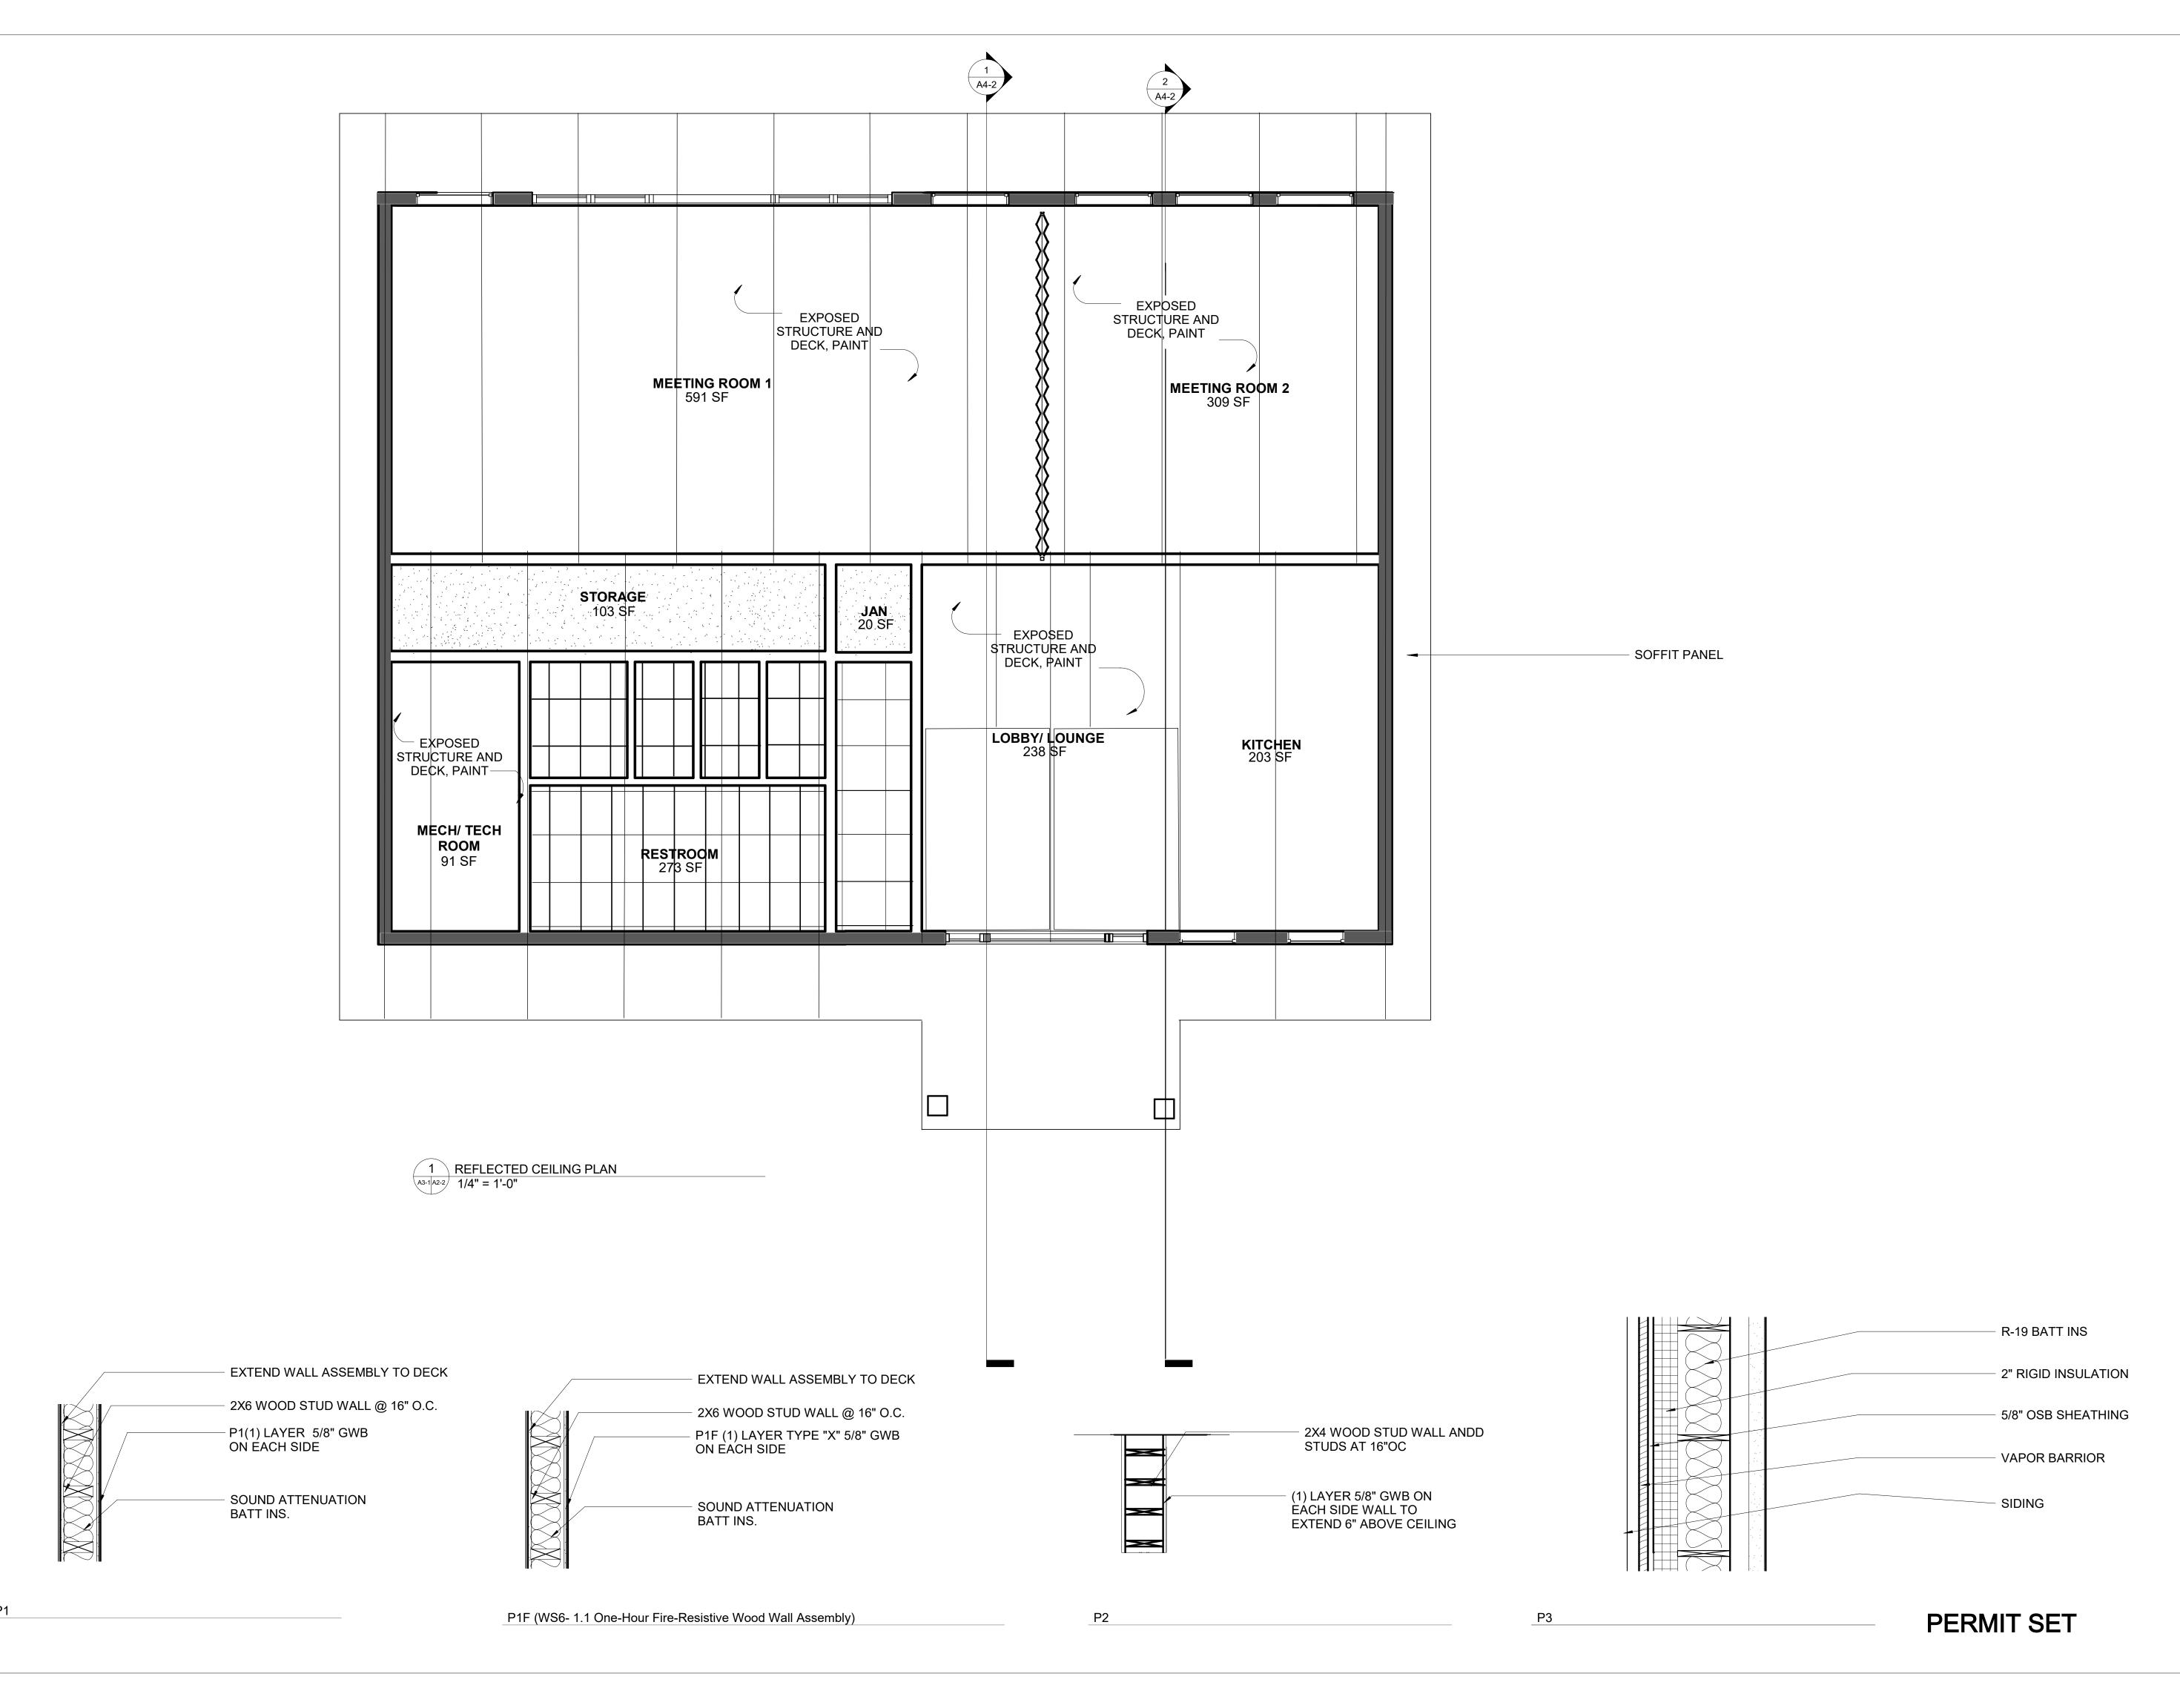


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443-565-043

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Engineers, Inc.

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COLLEGE PARK DESIGN-BUILD COMMUNITY SPACE

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> REFLECTED CEILING PLAN

DRAWING NO.

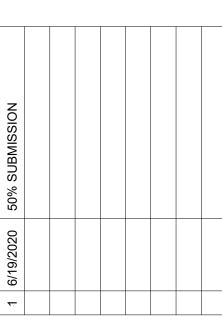A2-2

SCALE: As indicated


CP JOB NO.: CP-19-05

SPA JOB NO.: 19-022

DATE: 11/11/2020

DESIGNED BY: Designer
DRAWN BY: Author
CHECKED BY: Checker



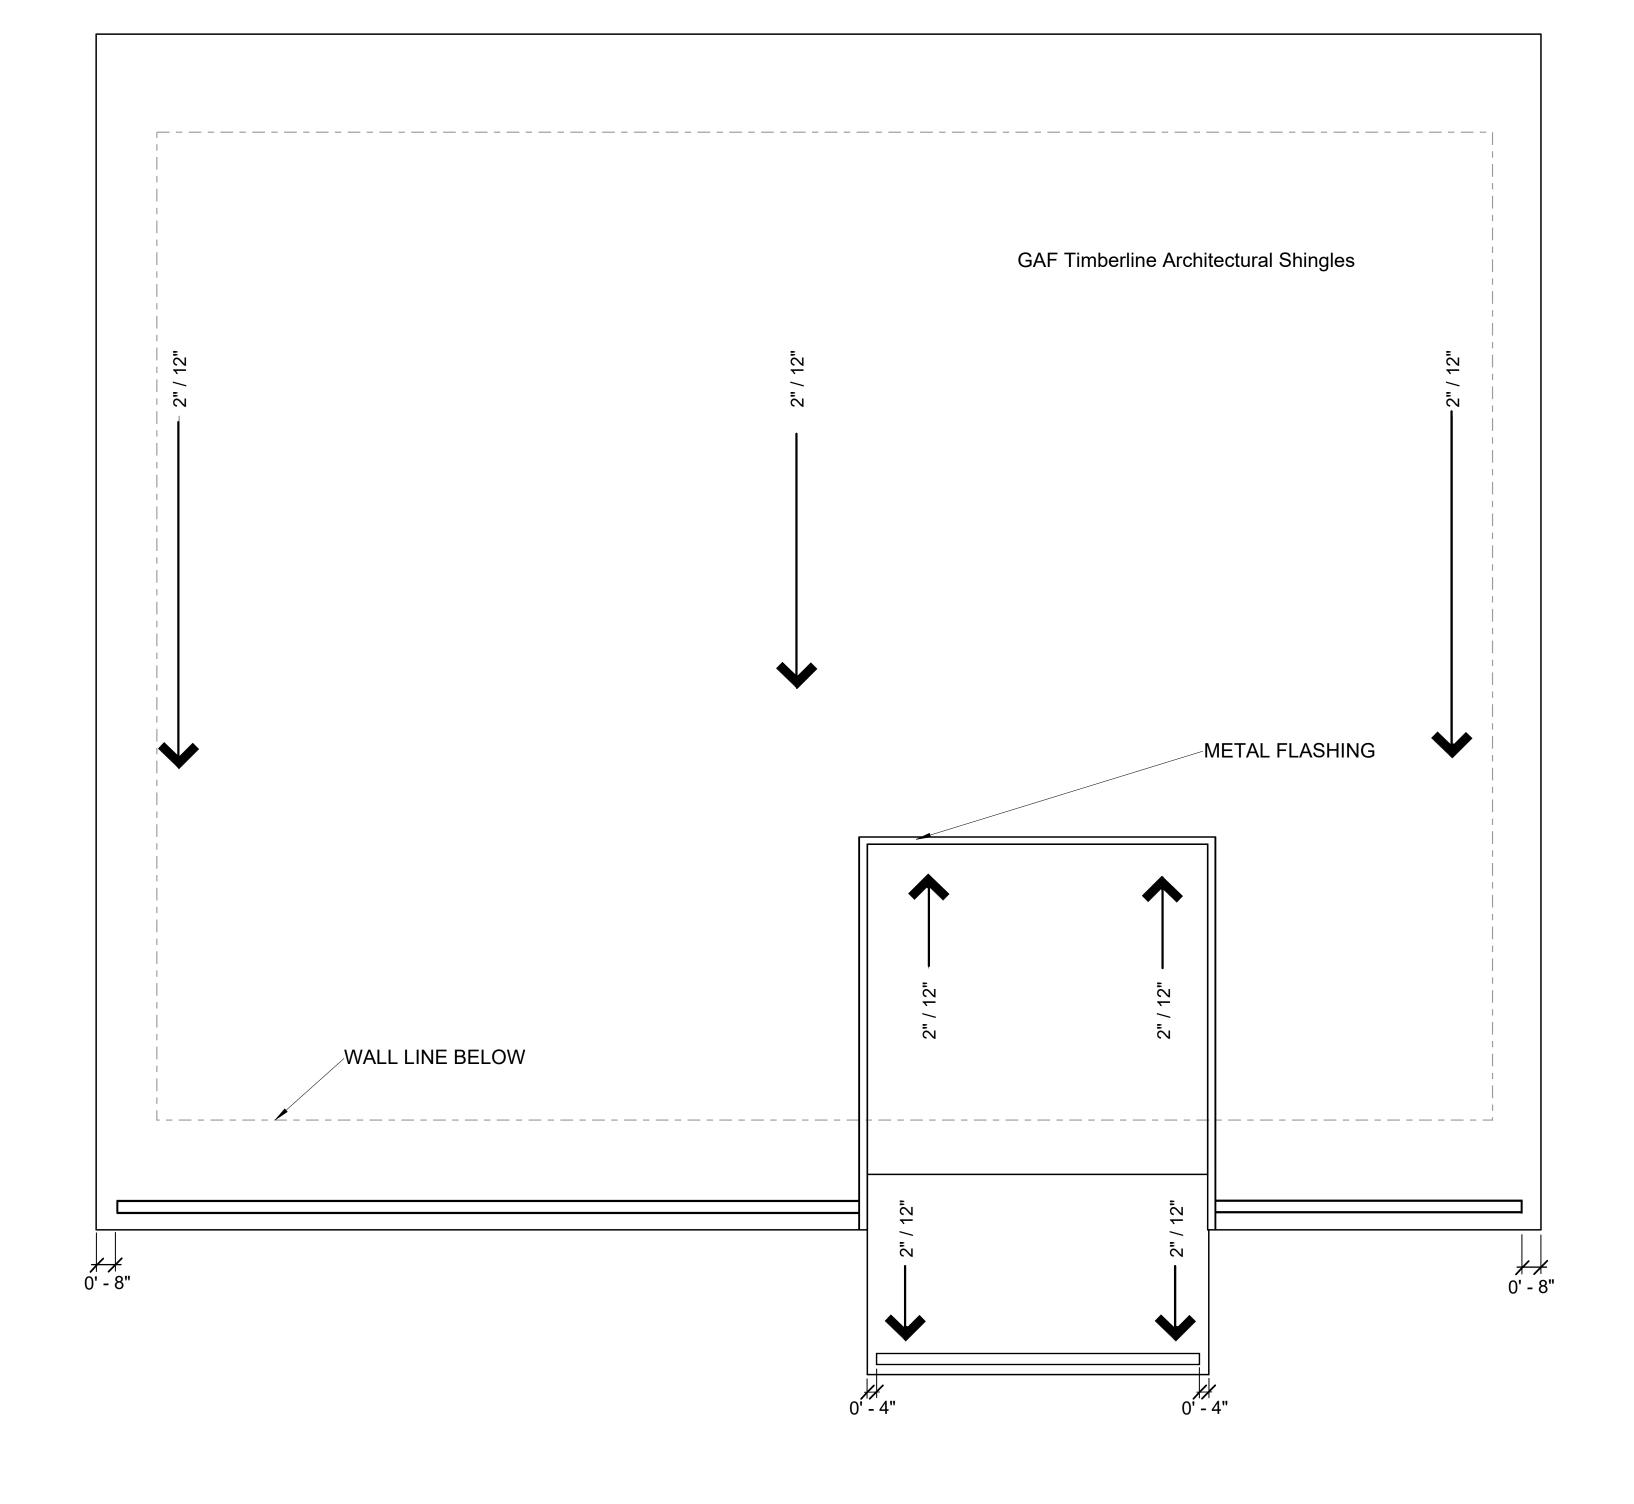

A3-1



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COLLEGE PARK DESIGN-BUILD COMMUNITY SPACE

3545 MARLBOROUGH WAY COLLEGE PARK, MD 20740

300F PLAN

DRAWING NO.

A2-3

SCALE: 1/4" = 1'-0"

CP JOB NO.: CP-19-05

SPA JOB NO.: 19-022

DATE: 11/11/2020


DESIGNED BY: Designer
DRAWN BY: Author
CHECKED BY: Checker


APPROVED BY: Approver

1 ROOF PLAN

A3-1 A2-3 1/4" = 1'-0"



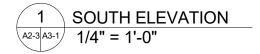

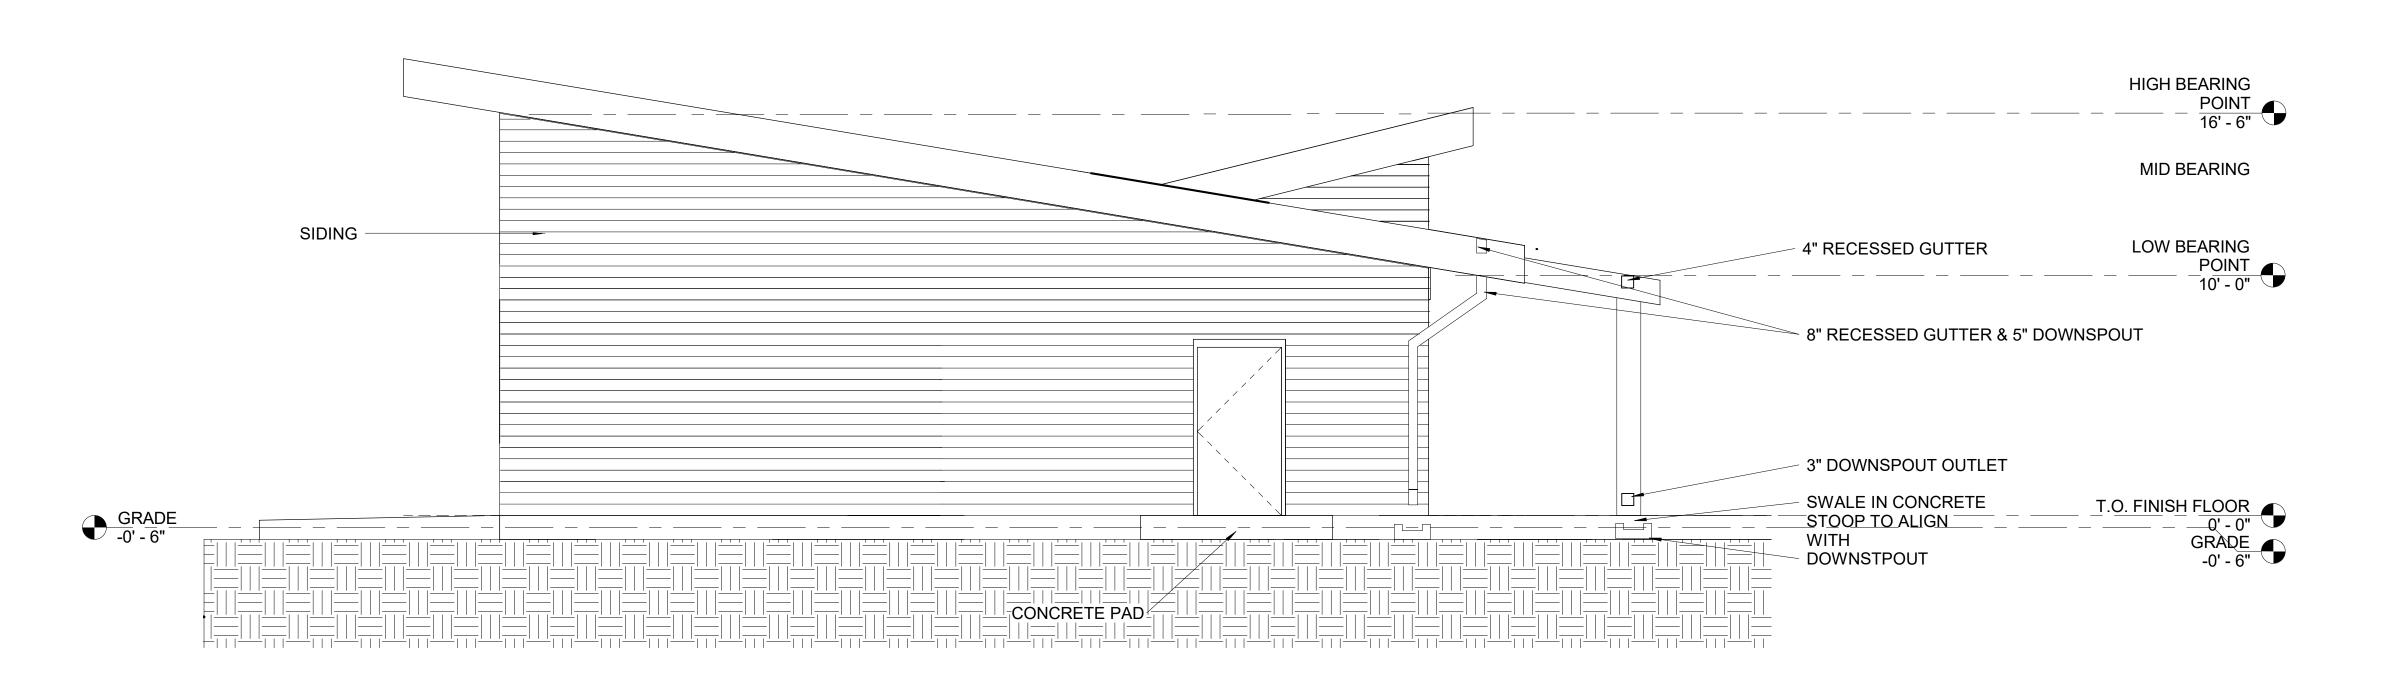

2 WEST ELEVATION
A2-3 A3-1 1/4" = 1'-0"

PERMIT SET




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COLLEGE PARK DESIGN-BUILD COMMUNITY SPACE

3545 MARLBOROUGH WAY COLLEGE PARK, MD 20740

ELEVATIONS

DRAWING NO.

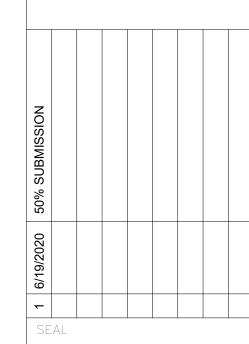A3-1

SCALE: 1/4" = 1'-0"


CP JOB NO.: CP-19-05

SPA JOB NO.: 19-022


DATE: 11/11/2020

APPROVED BY: KS

DESIGNED BY: Designer
DRAWN BY: KA
CHECKED BY: KS

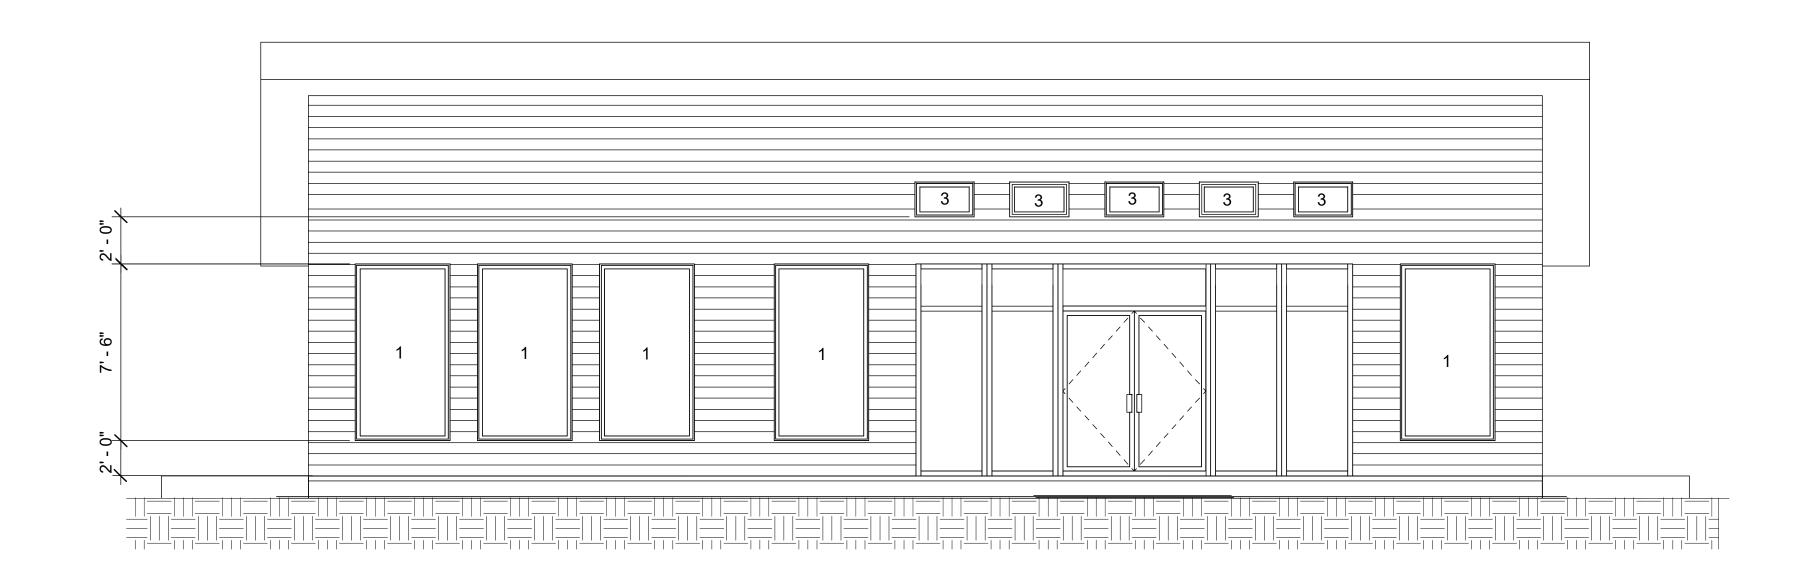

1 NORTH ELEVATION A2-3 A3-2 1/4" = 1'-0"

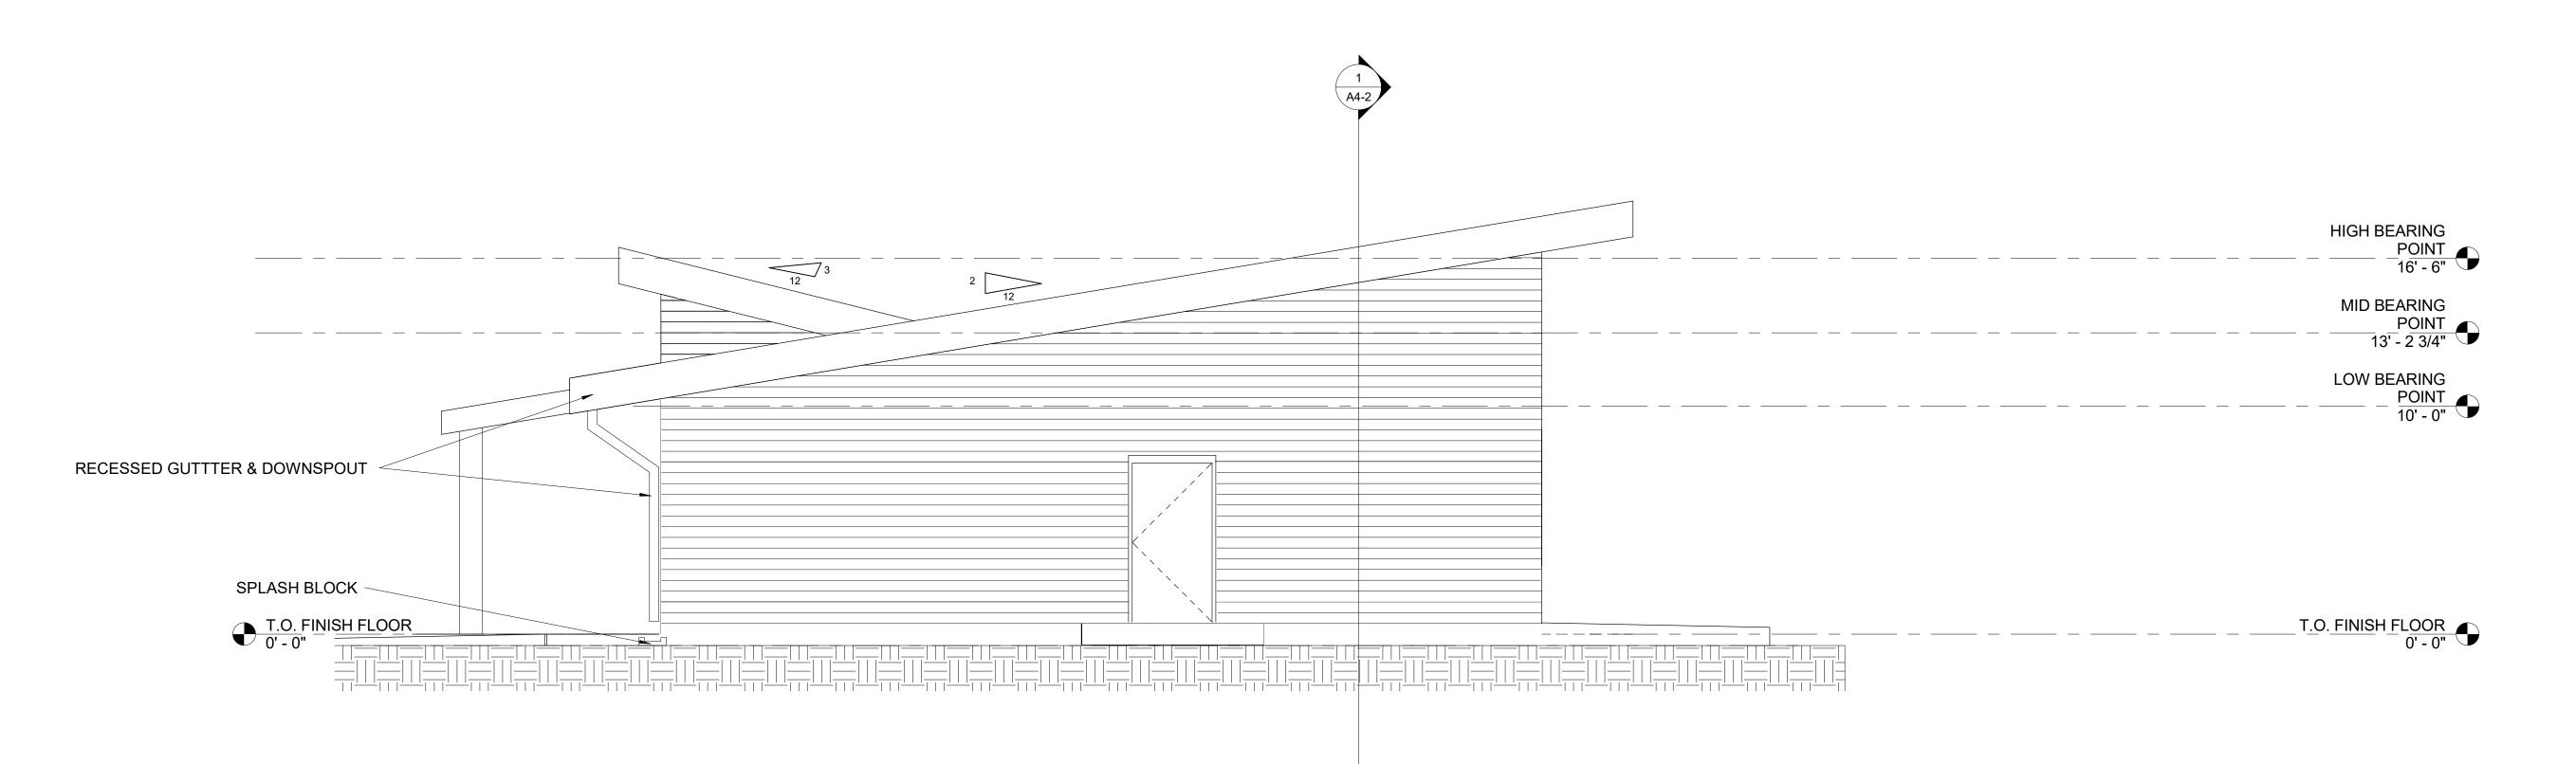

2 EAST ELEVATION A2-3 A3-2 1/4" = 1'-0"

PERMIT SET




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SINCITAVA IS

DRAWING NO.

A3-2

SCALE: 1/4" = 1'-0"

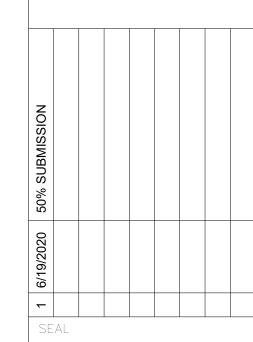CP JOB NO.: CP-19-05


SPA JOB NO.: 19-022


DATE: 11/11/2020


DESIGNED BY: Designer
DRAWN BY: Author


CHECKED BY: Checker

APPROVED BY: Approver

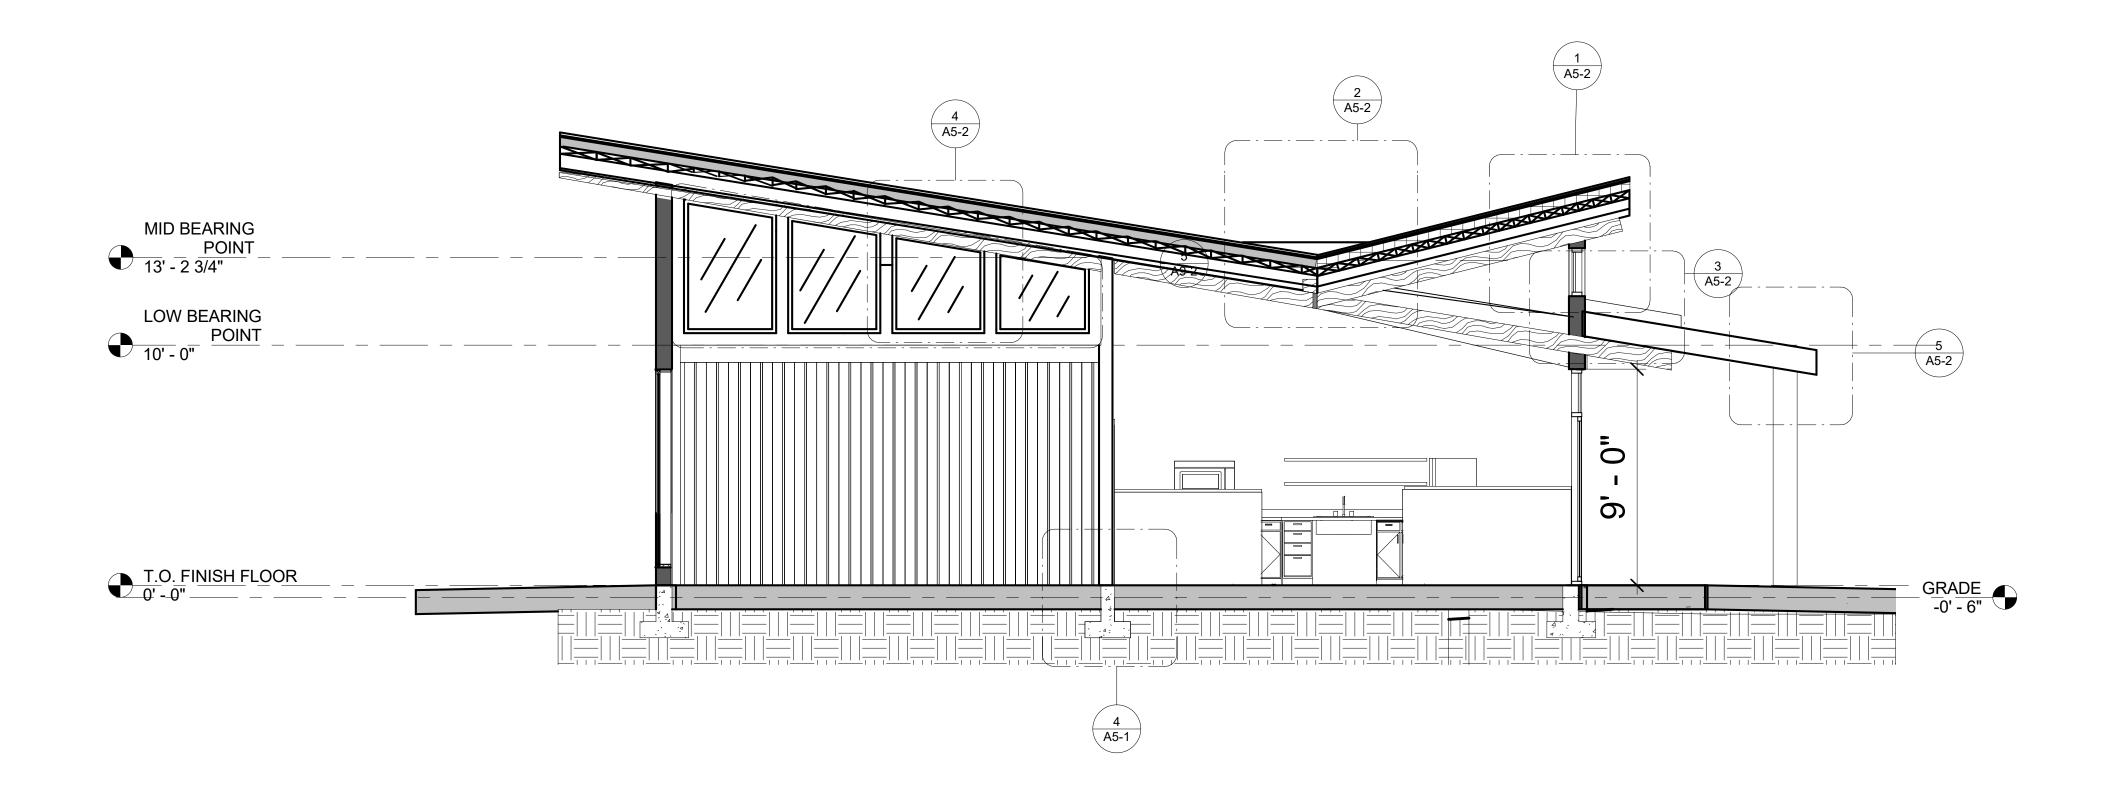

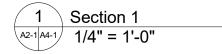

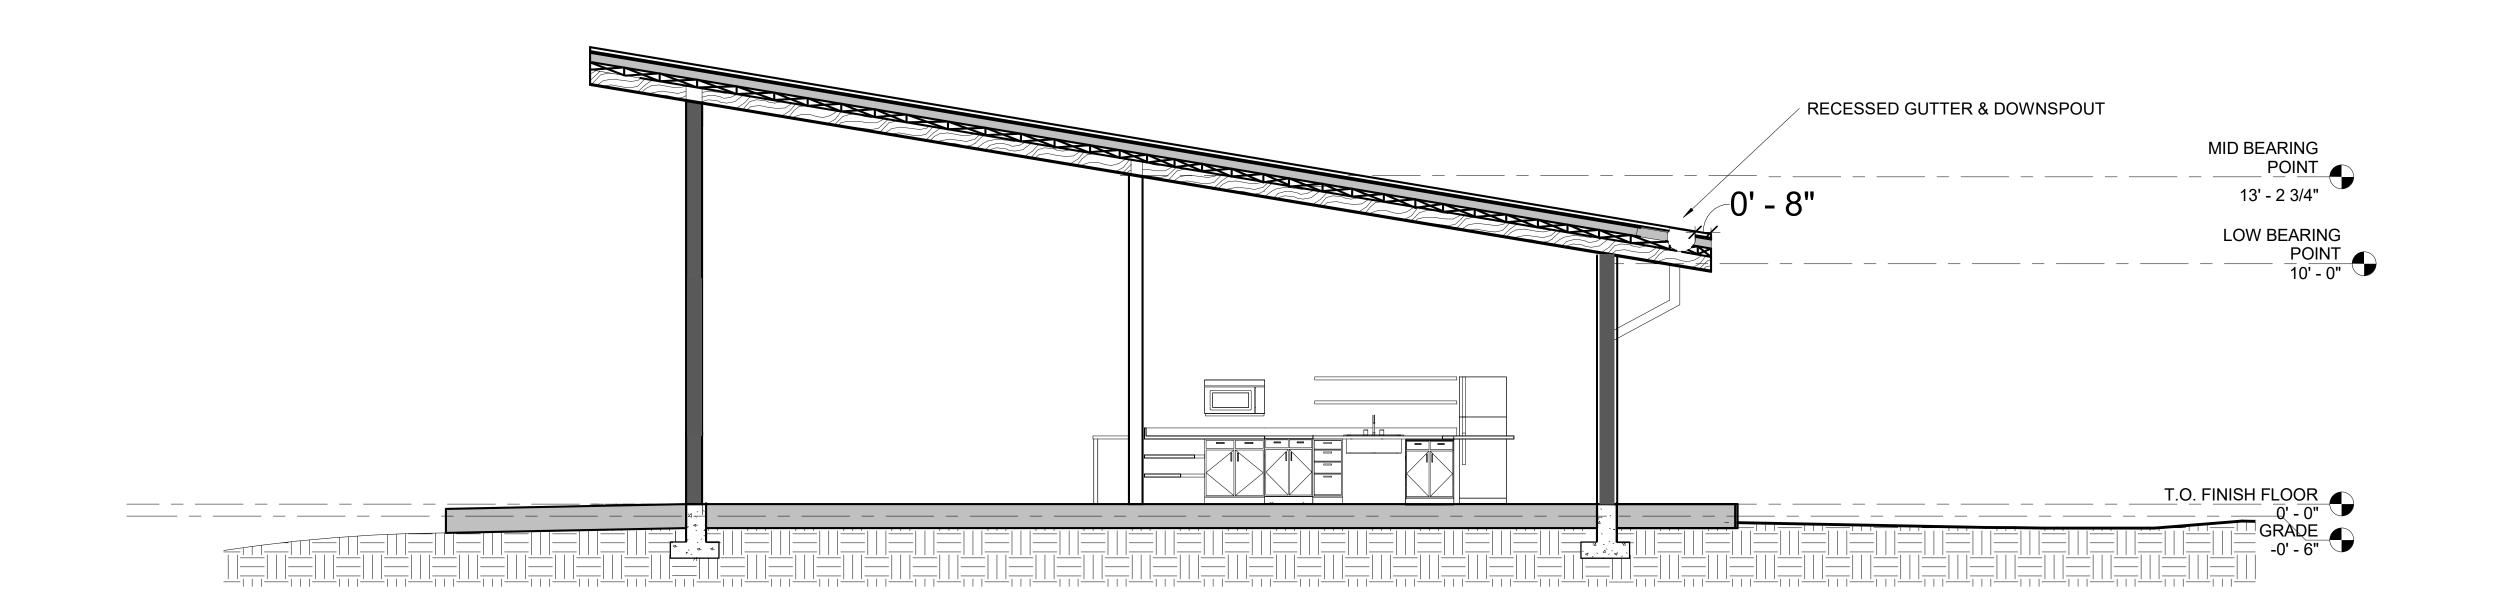

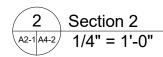


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ARCHITECT

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COLLEGE PARK DESIGN-BUILD COMMUNITY SPACE

3545 MARLBOROUGH WAY COLLEGE PARK, MD 20740

BUILDING SECTIONS

DRAWING NO.

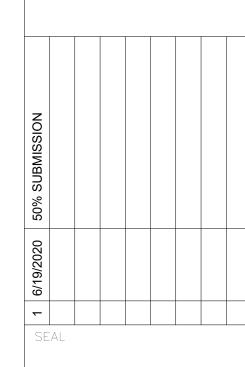A4-1


SCALE: 1/4" = 1'-0"


CP JOB NO.: CP-19-05


SPA JOB NO.: 19-022

DATE: 11/11/2020

DESIGNED BY: Designer
DRAWN BY: Author
CHECKED BY: Checker

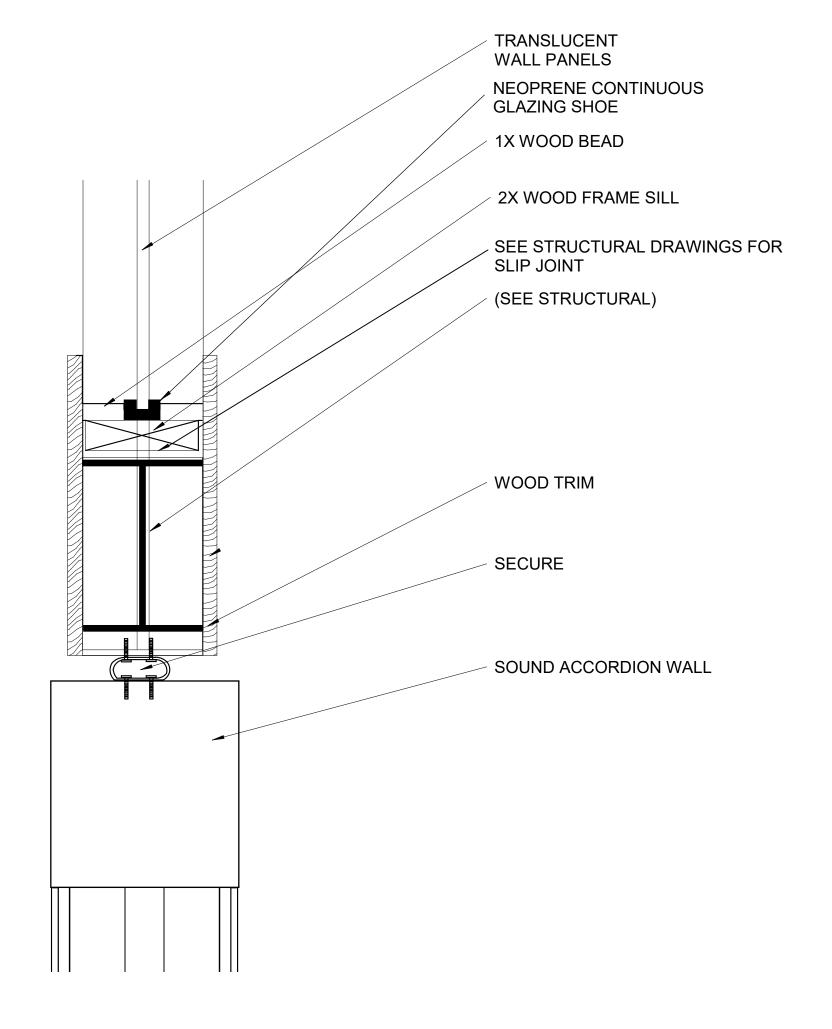

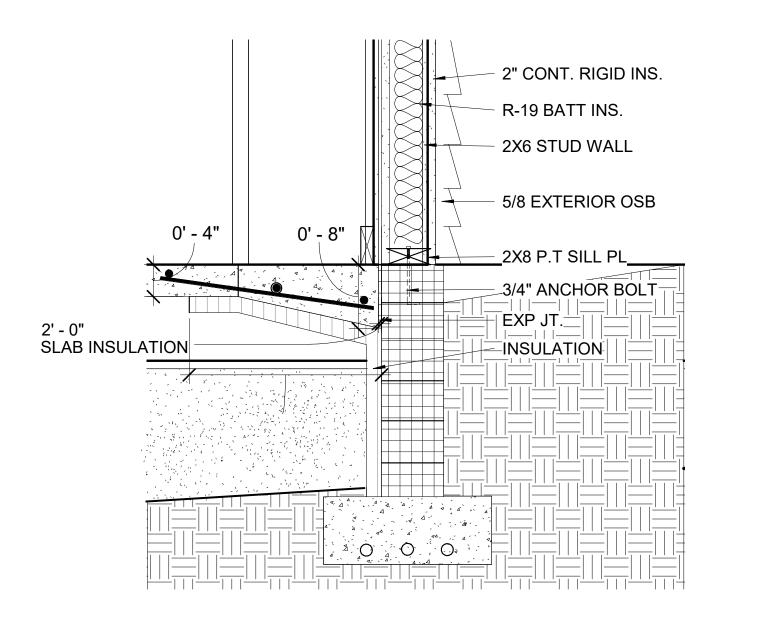

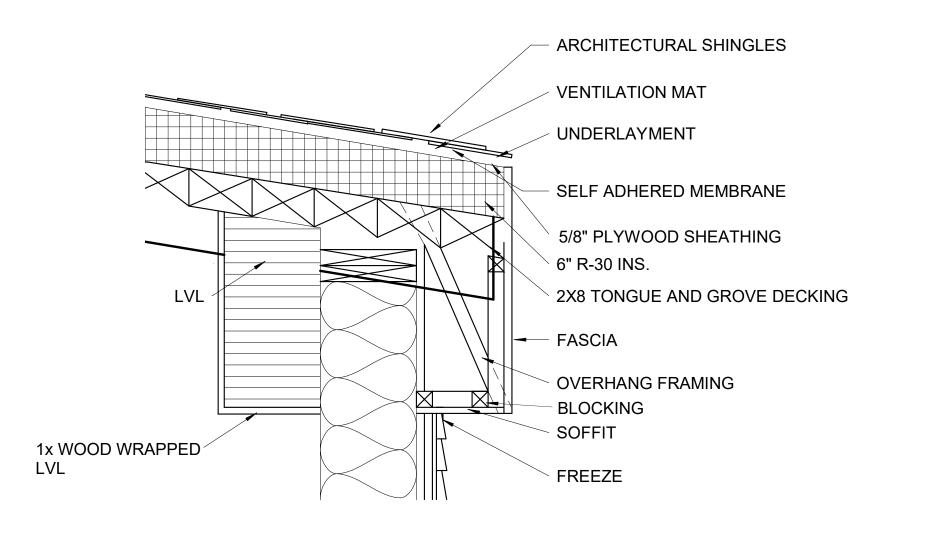

PARTITION HEADER DETAIL

A4-2 A5-2 3" = 1'-0"

4 FOUNDATION DETAIL 1

A4-1 A5-2 1" = 1'-0"

5 ROOF DETAIL

A4-1 A5-2 1" = 1'-0"

A5-2

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COLLEGE PARK DESIGN-BUILD COMMUNITY **SPACE**

3545 MARLBOROUGH WAY COLLEGE PARK, MD 20740

SECTIONS

DRAWING NO.


A5-1


SCALE: As indicated CP JOB NO.: CP-19-05 SPA JOB NO.: 19-022


DATE: 11/11/2020 DESIGNED BY: Designer DRAWN BY: Author CHECKED BY: Checker

APPROVED BY: Approver


A5-2

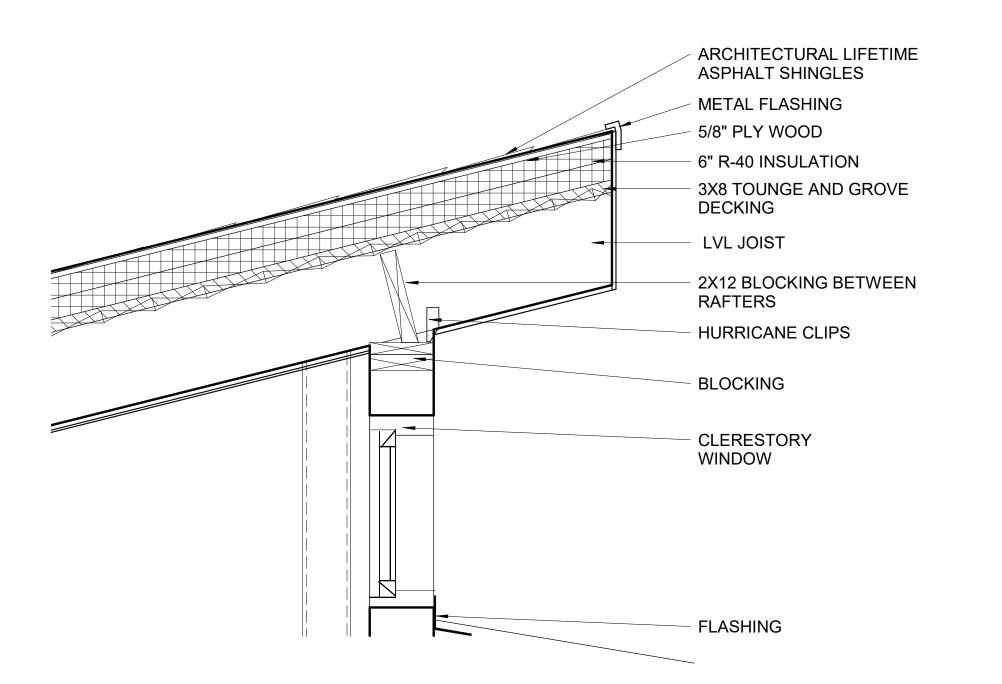


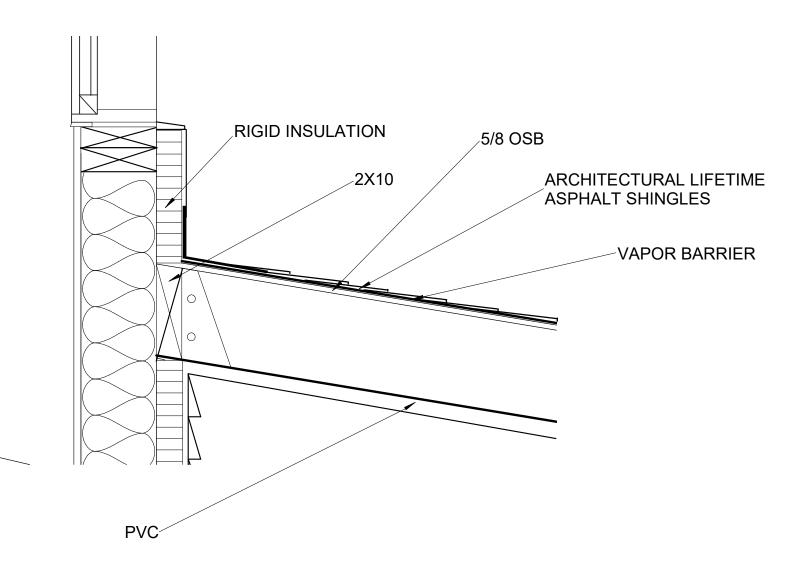


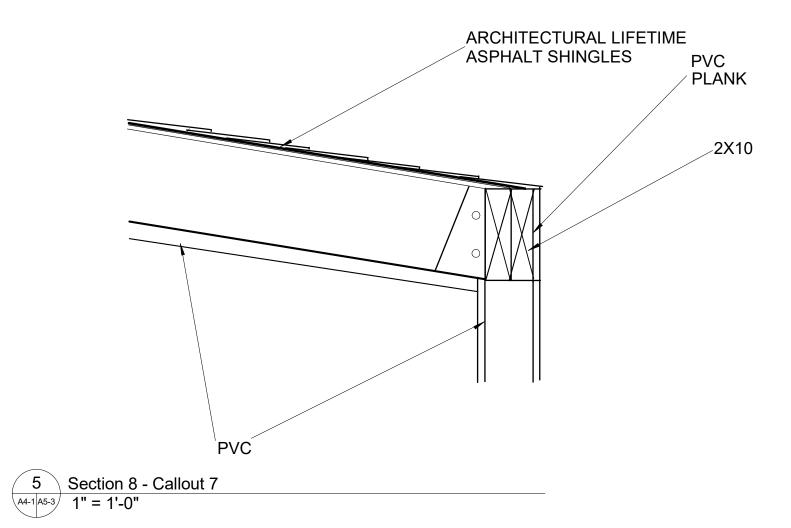

1 Section 8 - Callout 3
A4-1 A5-3 1" = 1'-0"

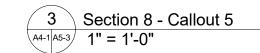

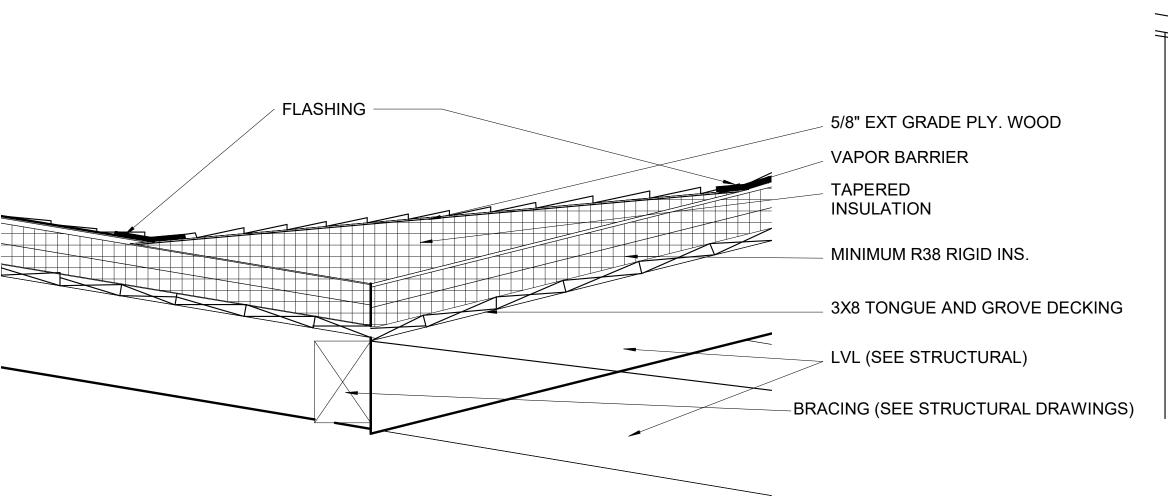

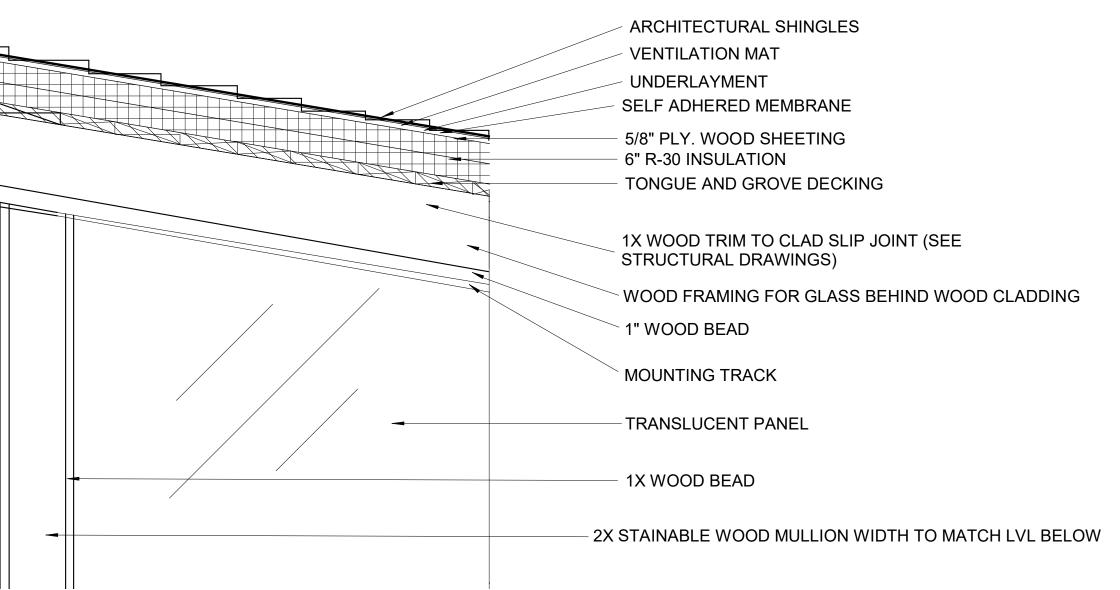

2 TRANSITION DETAIL AT ROOF SLOPE CHANGE
A4-1 A5-3 1" = 1'-0"



PERMIT SET


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COLLEGE PARK DESIGN-BUILD COMMUNITY SPACE

3545 MARLBOROUGH WAY COLLEGE PARK, MD 20740

WALL SECTION DETAILS

DRAWING NO.

A5-2

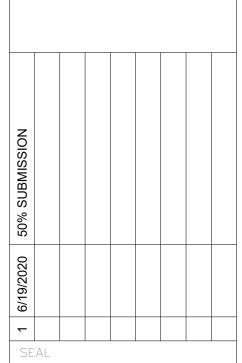
SCALE: 1" = 1'-0"

CP JOB NO.: CP-19-05

SPA JOB NO.: 19-022


DATE: 11/11/2020


DESIGNED BY: Designer
DRAWN BY: Author
CHECKED BY: Checker

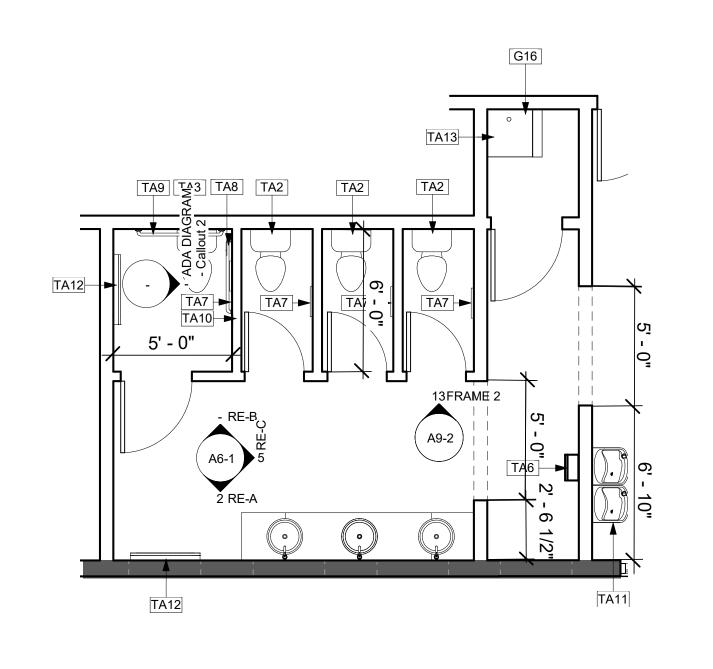


1 RESTROOM PLAN

A2-1 A6-1 1/4" = 1'-0"

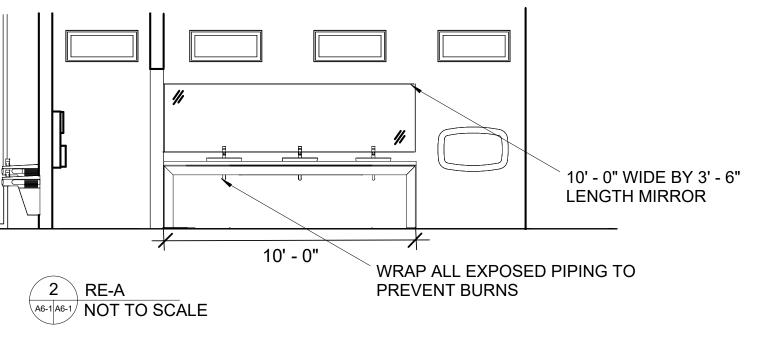

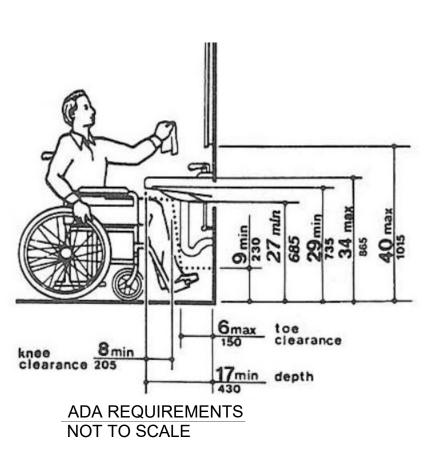

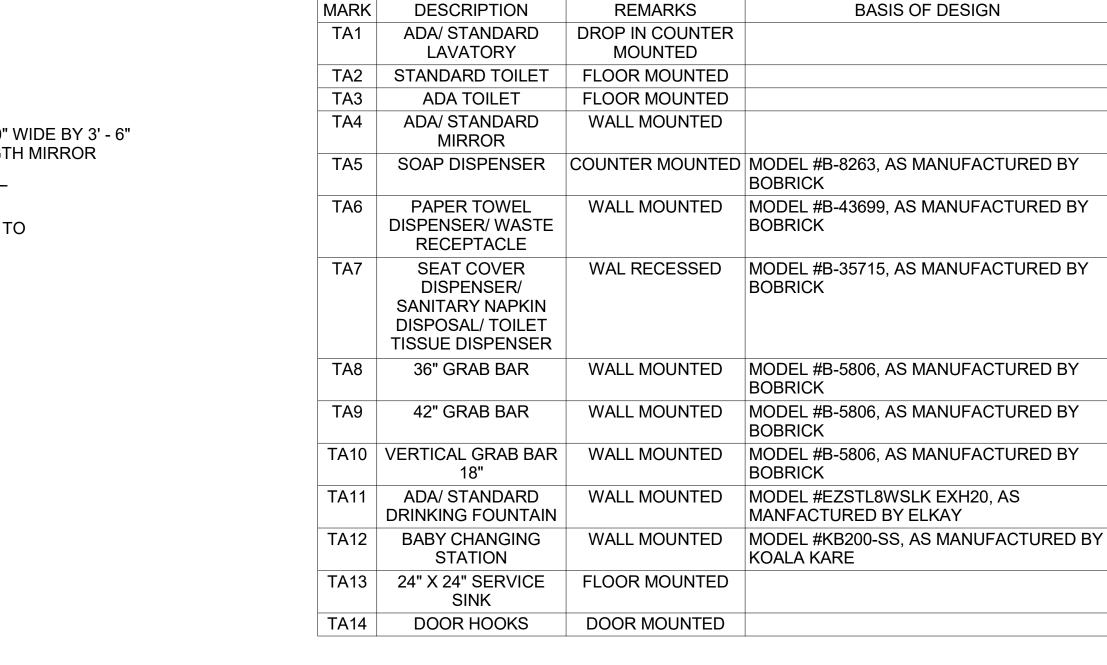


TOILET ACCESORIES SCHEDULE


		CASEWORK	SCHEDUI	F					
MARK	DESCRIPTION	TYPE	WIDTH	DEPTH	HEIGHT	NOTES			
04	D 4 O F		00"	0.411	00.5"				
G1	BASE CABINET	DOUBLE DOOR	30"	24"	32.5"				
G2	BASE CABINET	(4) DRAWER	15"	24"	32.5"				
G3	WALL CABINET	DOUBLE DOOR	30"	12"	30"				
G4	WALL CABINET	DOUBLE DOOR	30"	12"	12"				
G5	COUNTERTOP		AS SHOWN	32"	34"				
G6	COUNTERTOP	L SHAPED	AS SHOWN	25"	34"				
G7	COUNTERTOP		AS SHOWN	25"	34"				
G8	COUNTERTOP	L SHAPED	AS SHOWN	25"	34"				
G9	COUNTERTOP	WITH SINK HOLE	AS SHOWN	25'	34"				
G10	COUNTERTOP	ISLAND	AS SHOWN	25"	34"				
G11	COUNTERTOP	ISLAND	AS SHOWN	12"	48"				


			SHOWN			
G13	SINK	KITCHEN COUNTER MOUNT	30"	21"	AS SHOWN	
G14	SHELVING	WALL MOUNTED	AS SHOWN	12"	AS SHOWN	
G15	SHELVING	WALL MOUNTED	AS SHOWN	18"	AS SHOWN	
G16	SHELVING	WALL MOUNTED	AS SHOWN	48"	AS SHOWN	


	APPLICANCE S	CHEDULE	
MARK	DESCRIPTION	BASIS OF DESIGN	NOTES
A1	REFRIGERATOR		
A2	DISHWASHER		
A3	VA/A DA 4ED		
AS	WARMER		


BABY CHANGING STATION
36" GRAB BAR
TOILET TISSUE DISPENSER 188 198 198 198 198 198 198 19

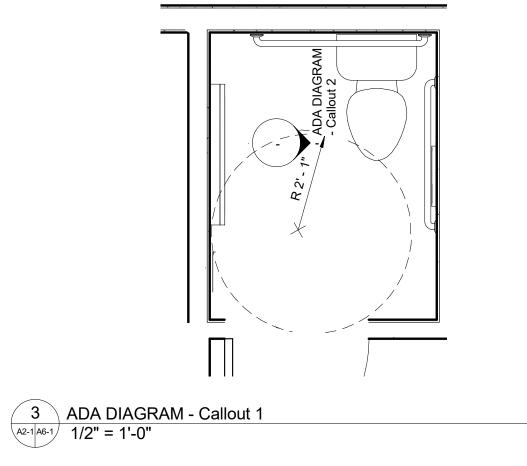

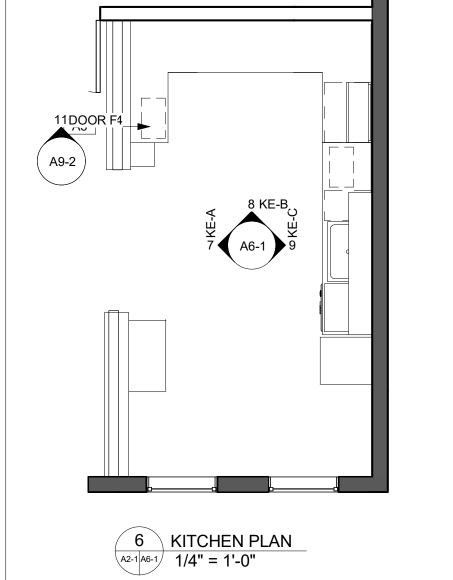

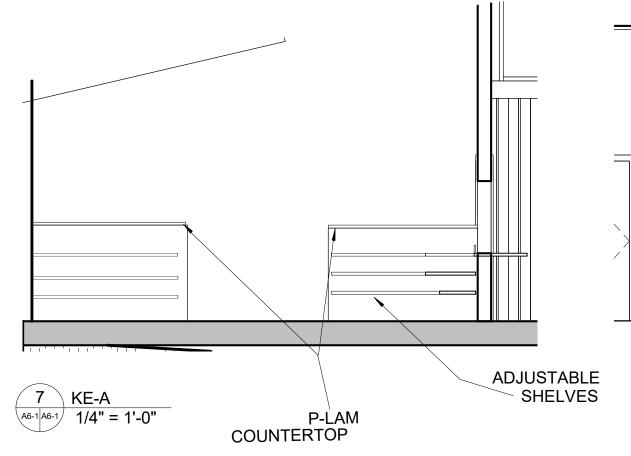

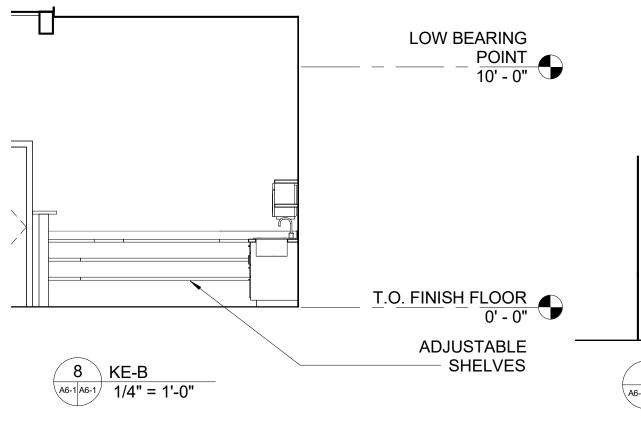

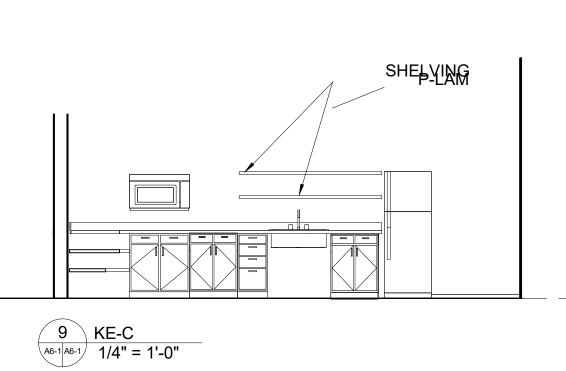

T.O. FINISH FLOOR 0' - 0"

PERMIT SET



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COLLEGE PARK

DESIGN-BUILD

COMMUNITY

SPACE

3545 MARLBOROUGH WAY COLLEGE PARK, MD 20740

RESTROOM AND KITCHEN ELEVATIONS

A6-1

SCALE: As indicated

SPA JOB NO.: 19-022


DATE: 11/11/2020

CP JOB NO.: CP-19-05

DESIGNED BY: Designer

DRAWN BY: Author CHECKED BY: Checker APPROVED BY: Approver

DRAWING NO.

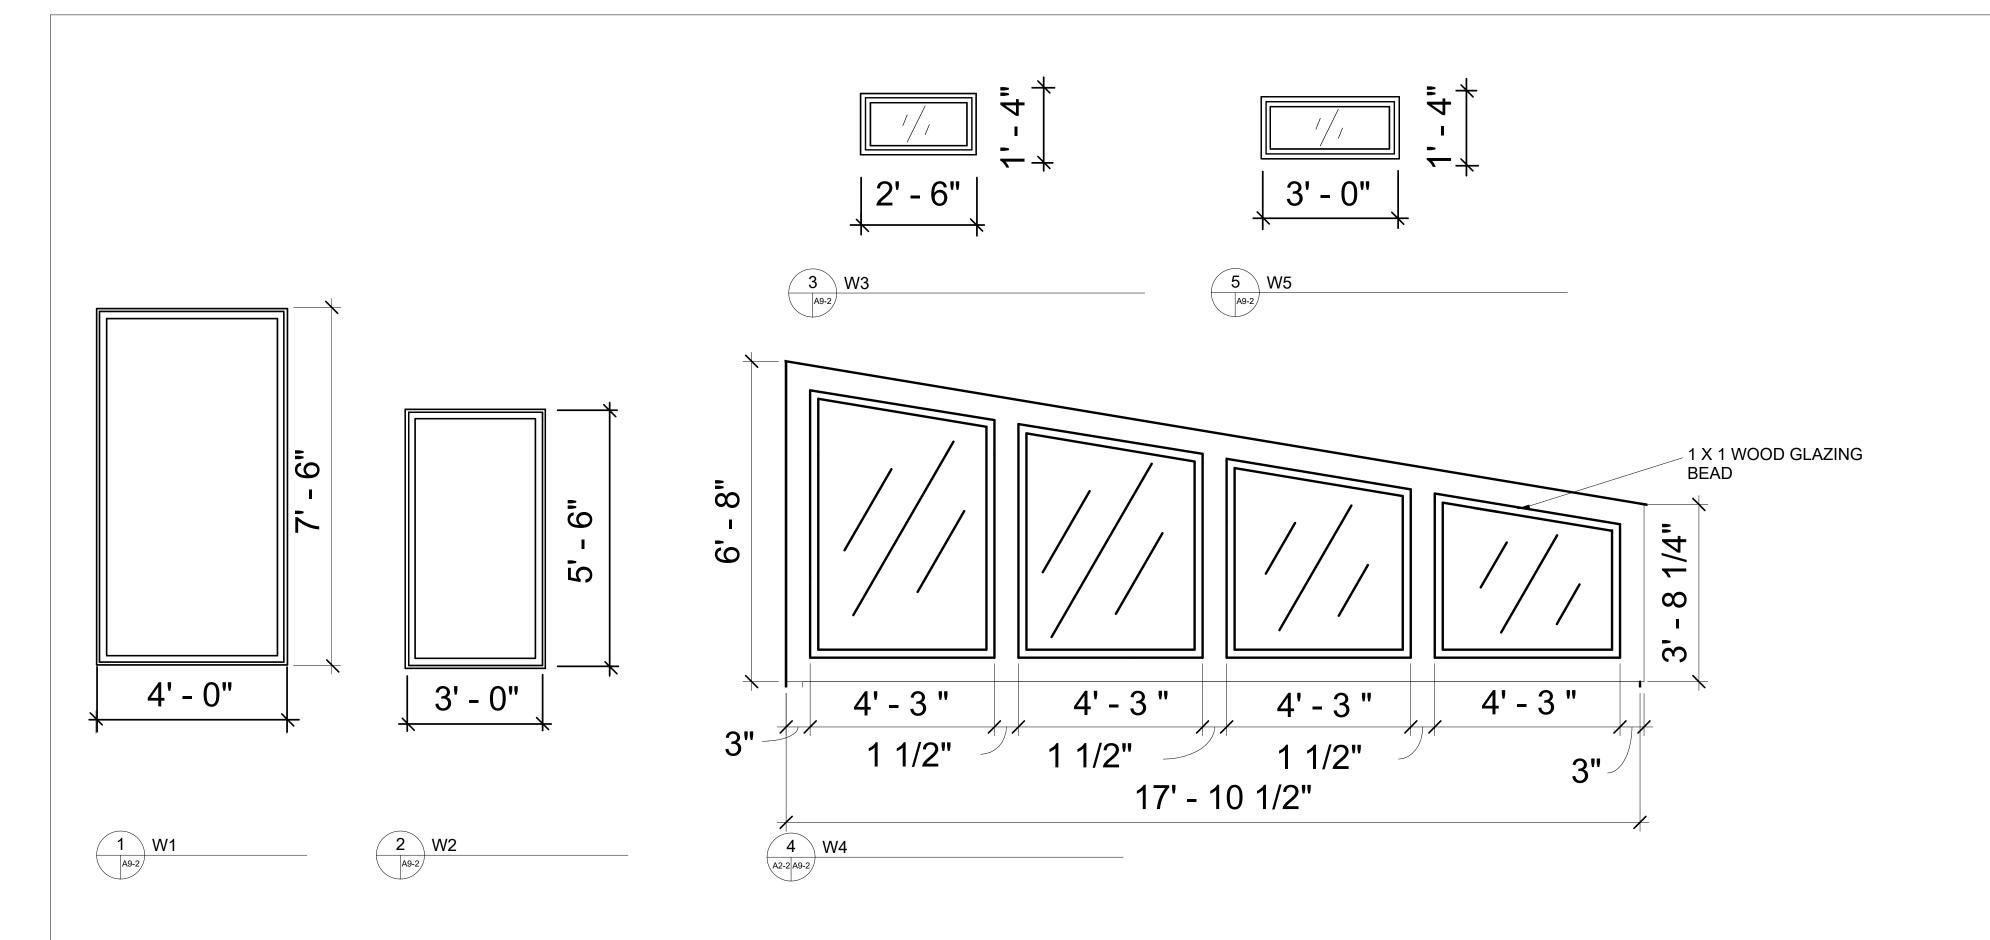


		W	INDOW SCHEDULE		
WINDOW NUMBER	WIDTH	HGT	MATERIAL	FIRE RATING	REMARKS
W1	4' - 0"	7' - 6"	ALUM/ GL	-	T14000
W2	3' - 0"	5' - 6"	ALUM/ GL	-	T14000
W3	2' - 6"	1' - 4"	ALUM/ GL		T14000
W4	17' - 10 1/2"	VARIES	TRANSLUCENT PANEL/ WD.		
W5	3' - 0"	1' - 4"	ALUM/ GL		T14000

				DOOR	SCHEDULE				
DOOR	WIDTH	LICT	FIRE	DOOR	DOOR	FRAME	FRAME	HW	DEMARKS
NUMBER	WIDTH	HGT	RATING	MATERIAL	TYPE	TYPE	MATERIAL	SET	REMARKS
1	6'-0"	7'-0"		ALUM/GLASS	С	3	ALUM	1	T14000
2	3'-0"	7'-0"		WOOD	E	2	НМ	3	
3	3'-0"	7'-0"		WOOD	Е	2	НМ	3	
4	3'-0"	7'-0"		WOOD	F	2	НМ	4	
5	2'-6"	7'-0"		WOOD	D	4	НМ	6	
6	2'-6"	7'-0"		WOOD	D	4	НМ	6	
7	2'-6"	7'-0"		WOOD	D	4	НМ	6	
8	3'-0"	7'-0"		WOOD	F	2	НМ	6	
9	3'-0"	7'-0"		HM	F	2	НМ	5	
10	6'-0"	7'-0"		WOOD	В	1	НМ	4	
11	6'-0"	7'-0"		WOOD	В	1	НМ	4	
12	6'-0"	7'-0"		ALUM/GLASS	С	3	ALUM	1	T14000
13	3'-0"	7'-0"		HM	А	2	НМ	7	
					_				

ALL STORE FRONTS TO BE TUBELITE SYSTEM T14000 OR EQUAL

ALL EXTERIOR GLAZING TO BE 1" INSULATED GLAZING LOW "E" CONSISTING OF 1/4" FLOAT AND TEMPER IN ALL DOORS AND ALL WINDOWS WITHIN 24" OF A DOOR, AND ALL WINDOWS 24" ABOVE THE FINISHED FLOOR WITH THE FOLLOWING CRITERIA:


WINDOWS: U-VALUE 0.380, SC. 0.45 (SHADE COEFFICIENT)

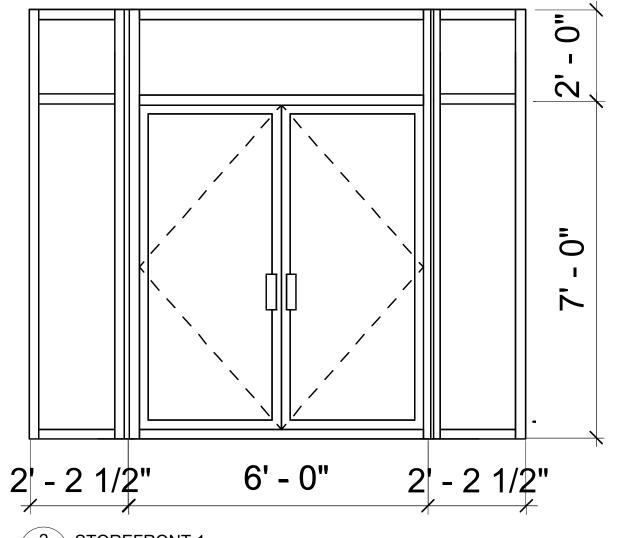

2 STOREFRONT 1

2 STOREFRONT 2

0

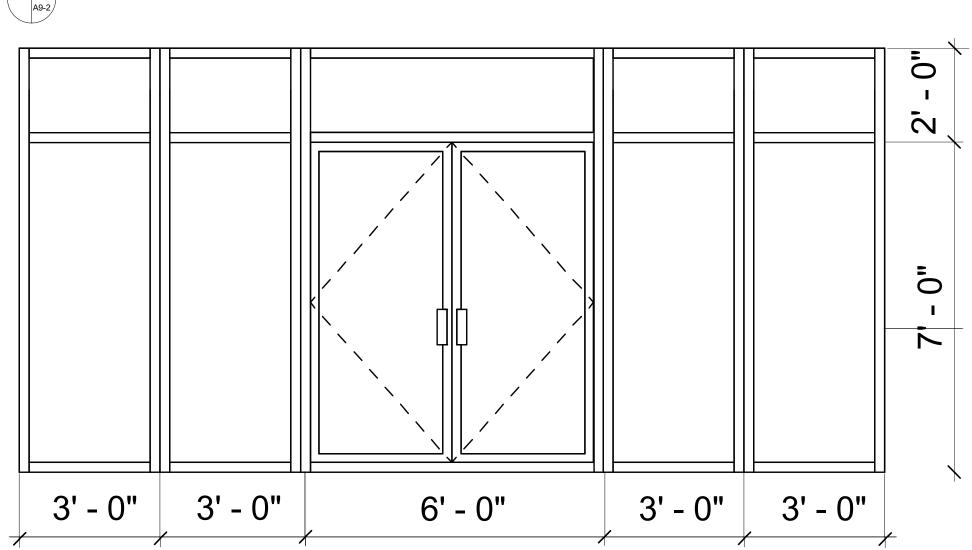

PERMIT SET

WINDOW AND DOOR
SCHEDULE

DRAWING NO.

A9-1

SCALE: 1/2" = 1'-0"

CP JOB NO.: CP-19-05

SPA JOB NO.: 19-022

DATE: 11/11/2020

DESIGNED BY: Designer
DRAWN BY: Author
CHECKED BY: Checker

APPROVED BY: Approver

5 1/1 _ 0' - 6" 0 **.** / 0 3' - 0" 2' - 6" 5 DOOR A 6 DOOR B 9 DOOR E 8 DOOR D 0' - 2" 2' - 6" 0' - 2" **3** 0 0 0 0 0 0

12 FRAME 2

14 FRAME 4

3' - 0"

6' - 0"

11 FRAME 1

3' - 0"

0

3' - 0"

10 DOOR F

Tel: (410) 235–0057, Fox: (410) 235–0946
Email: info@jcengineers.net

TRUE NORTH PLAN NORTH

Consulting Engineers, Inc.

ARCHITECT

CIVIL/ STRUCTURAL

Sherrill + Partners + Architects, Inc.
Architecture Planning Inspections Interiors
3613 Milford Mill Rd.
Windsor Mill, MD 21244
443-565-0432

6/19/2020 50% SUBMISSION

PROFESSIONAL CERTIFICATION:

I certify that these documents were prepared or approved by me, and

prepared or approved by me, and that I am a duly licensed architect under the laws of the State of Maryland, license number _____, expiration date ______.

COLLEGE PARK DESIGN-BUILD COMMUNITY SPACE

3545 MARLBOROUGH WAY COLLEGE PARK, MD 20740

				II	NTERIO	R FINISH S	SCHEDULE		S Arch
DOOM NAME	WAL	.LS	DACE	FLC	OOR		C	DEMARKS	
ROOM NAME	MAT'L	FIN.	BASE	MAT'L	FIN	MAT'L	FIN.	HEIGHT	REMARKS
LOBBY	GWB	PAINT	VINYL	CONC	VCT	EXPOSED	STAIN	9'-0" SLOPED UP TO REAR	
MEETING RM 1	GWB	PAINT	VINYL	CONC	VCT	EXPOSED	STAIN	9'-0" SLOPED UP TO FRONT	
MEETING RM 2	GWB	PAINT	VINYL	CONC	VCT	EXPOSED	STAIN	9'-0" SLOPED UP TO FRONT	
KITCHEN	GWB	PAINT	VINYL	CONC	VCT	EXPOSED	STAIN	9'-0" SLOPED UP TO REAR	
CORRIDOR	GWB	PAINT	VINYL	CONC	VCT	ACT	ACT	9'-0"	
RESTROOM	GWB	PAINT/ VINYL	TILE	CONC	TILE	ACT	ACT	9'-0"	
MECH/ELEC ROOM	GWB	PAINT	VINYL	CONC	SEALED	EXPOSED	EXPOSED	EXPOSED	
STORAGE	GWB	PAINT	VINYL	CONC	SEALED	ACT	ACT	9'-0"	
JANITOR CLOSET	GWB	PAINT	VINYL	CONC	SEALED	ACT	ACT	9'-0"	

		HARDWARE SCHI	EDULE
MARK	QTY	TYPE	GENERAL DESCRIPTION
	1 EACH	CONCEALED CLOSER	
	3 PAIR	HINGES	
	1 EACH	EXIT DEVICE W/ CONCEALED FLUSH BOLT TOP AND BOTTOM & CYLINDER DOGGING	
HW1	1	THRESHOLD	THERMALLY BROKEN MAX. 37 HT. A.F.F, BEVELED W/ S NOT GREATER THAN 17 (ADA COMPLAINT)
	2 EACH	SILENCERS	
	1 EACH	PULL	
	1 SET	WEATHER STRIPPING	AT ALL SIDES OF FRAME AND AT DOOR MEETING
	2	CLOSER	NOT USED
	3 PAIR	HINGES	
HW2	3 EACH	SILENCER	
	2	KICK PLATE	
	1 EA	PULL/ PUSH PLATE	
	1	CLOSER	
	1 ½ PAIR	HINGES	
HW3	3	SILENCER	
	1	WALL STOP	
	1	KICK PLATE	10" X 36"
	1	CLOSER	
1 1147 4	3	SILENCER	
HW4	1	KEYED LEVER WITH LOCK AND THUMB TURN	
	1	WALL STOP	
	1 ½ PAIR	HINGES	
	1	THRESHOLD	THERMALLY BROKEN MAX. 37" HT. A.F.F, BEVELED W/ S
HW5	3	SILENCER	
	1	LEVER AND DEADBOLT LOCK WITH THUMB TURN	
	1 SET	WEATHER STRIPPING	
	1 1/2 PAIRS	HINGES	
HW6	3	SILENCER	
	1	LEVER WITH THUMB TURN LOCK	
	1 EACH	CONCEALED CLOSER	
	1 1/2 PAIR	HINGES	
HW7	1 EACH	EXIT DEVICE W/ LATCHING CYLINDER DOGGING AND LEVER	
	1	THRESHOLD	THERMALLY BROKEN MAX. 3" HT. A.F.F, BEVELED W/ S NOT GREATER THAN 1" (ADA COMPLAINT)

PERMIT SET




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Engineer pt.

TRUE NORTH PLAN NORTH



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COLLEGE PARK DESIGN-BUILD COMMUNITY SPACE

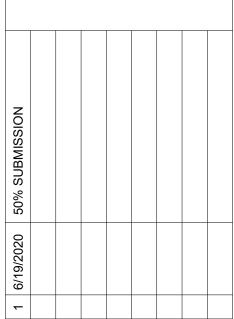3545 MARLBOROUGH WAY COLLEGE PARK, MD 20740

SCHEDULES

DRAWING NO.

A9-2

SCALE: 1/2" = 1'-0"

CP JOB NO.: CP-19-05

SPA JOB NO.: 19-022

DATE: 11/11/2020

DESIGNED BY: Designer

DESIGNED BY: Designer
DRAWN BY: Author
CHECKED BY: Checker